

PARTIAL ROOF PLAN — HVAC DEMOLITION

1/8"=1'-0"

ASSOCIATES, INC.

Design/Planning/Construction 1201 Main Street, Suite 2100 Columbia, S.C. 29201 tel. 803-256-0000 fax 803-255-7243

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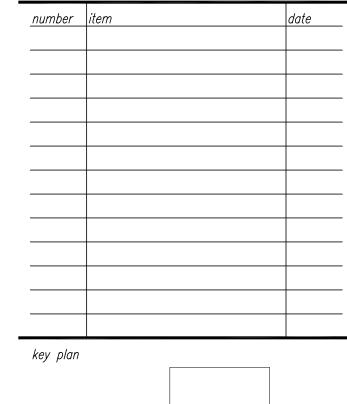



COKER - 7th FLOOR
PHARMACY RENOVATION
State project number
H27- 6101
project number
12023.01

seals/signature

issued for CONSTRUCTION

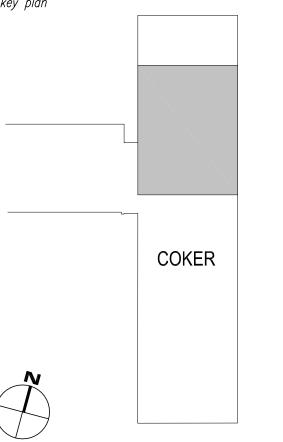date APRIL 23, 2013






PARTIAL SEVENTH FLOOR & ROOF
PLAN - HVAC DEMOLITION

sheet number

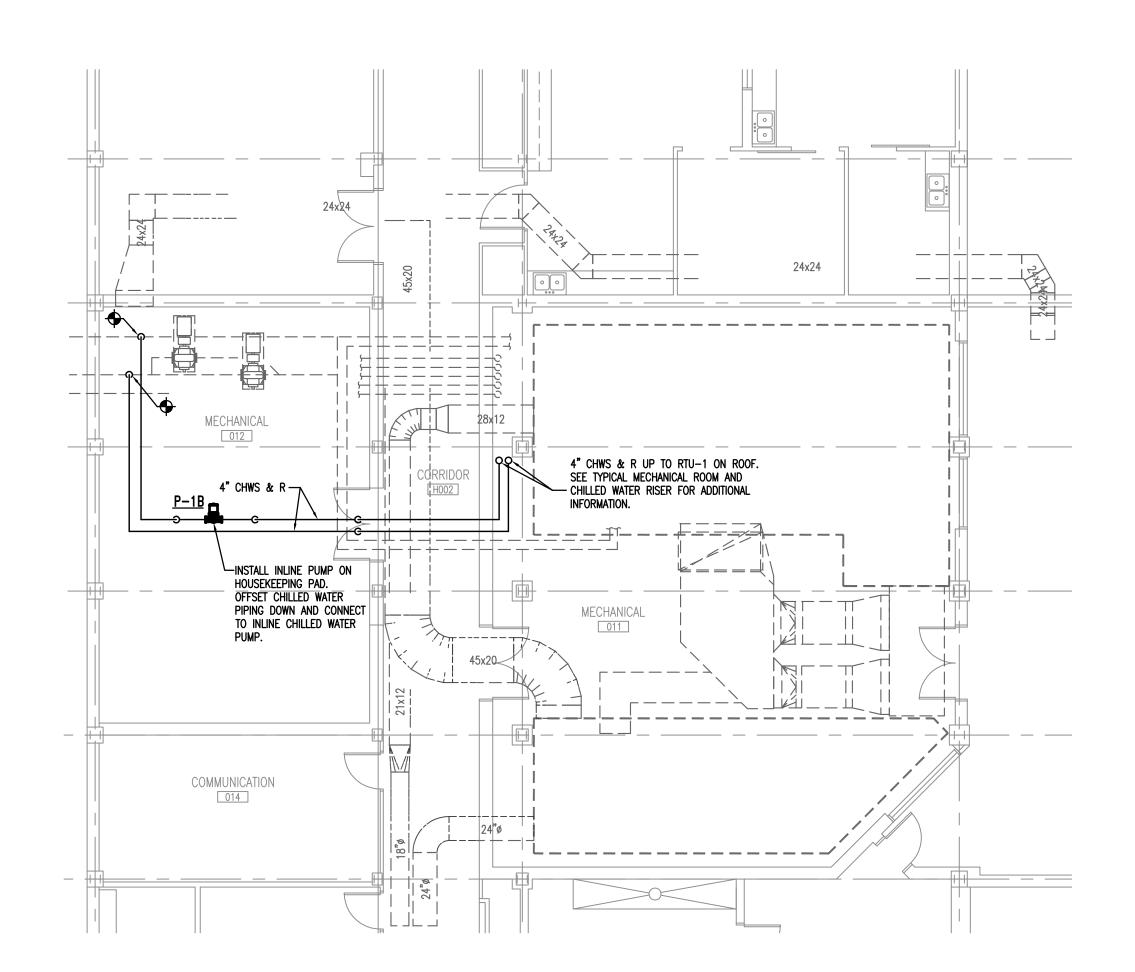M1.



1 PARTIAL BASEMENT FLOOR PLAN - HVAC RENOVATIONS

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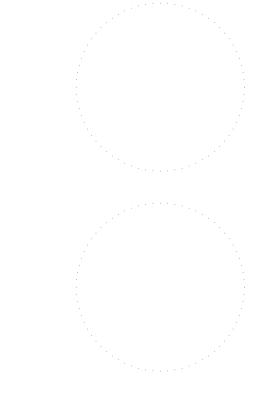
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project name COKER - 7th FLOOR PHARMACY RENOVATION State project number

H27-6101 project number 12023.01

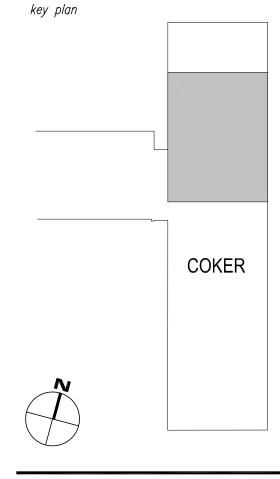
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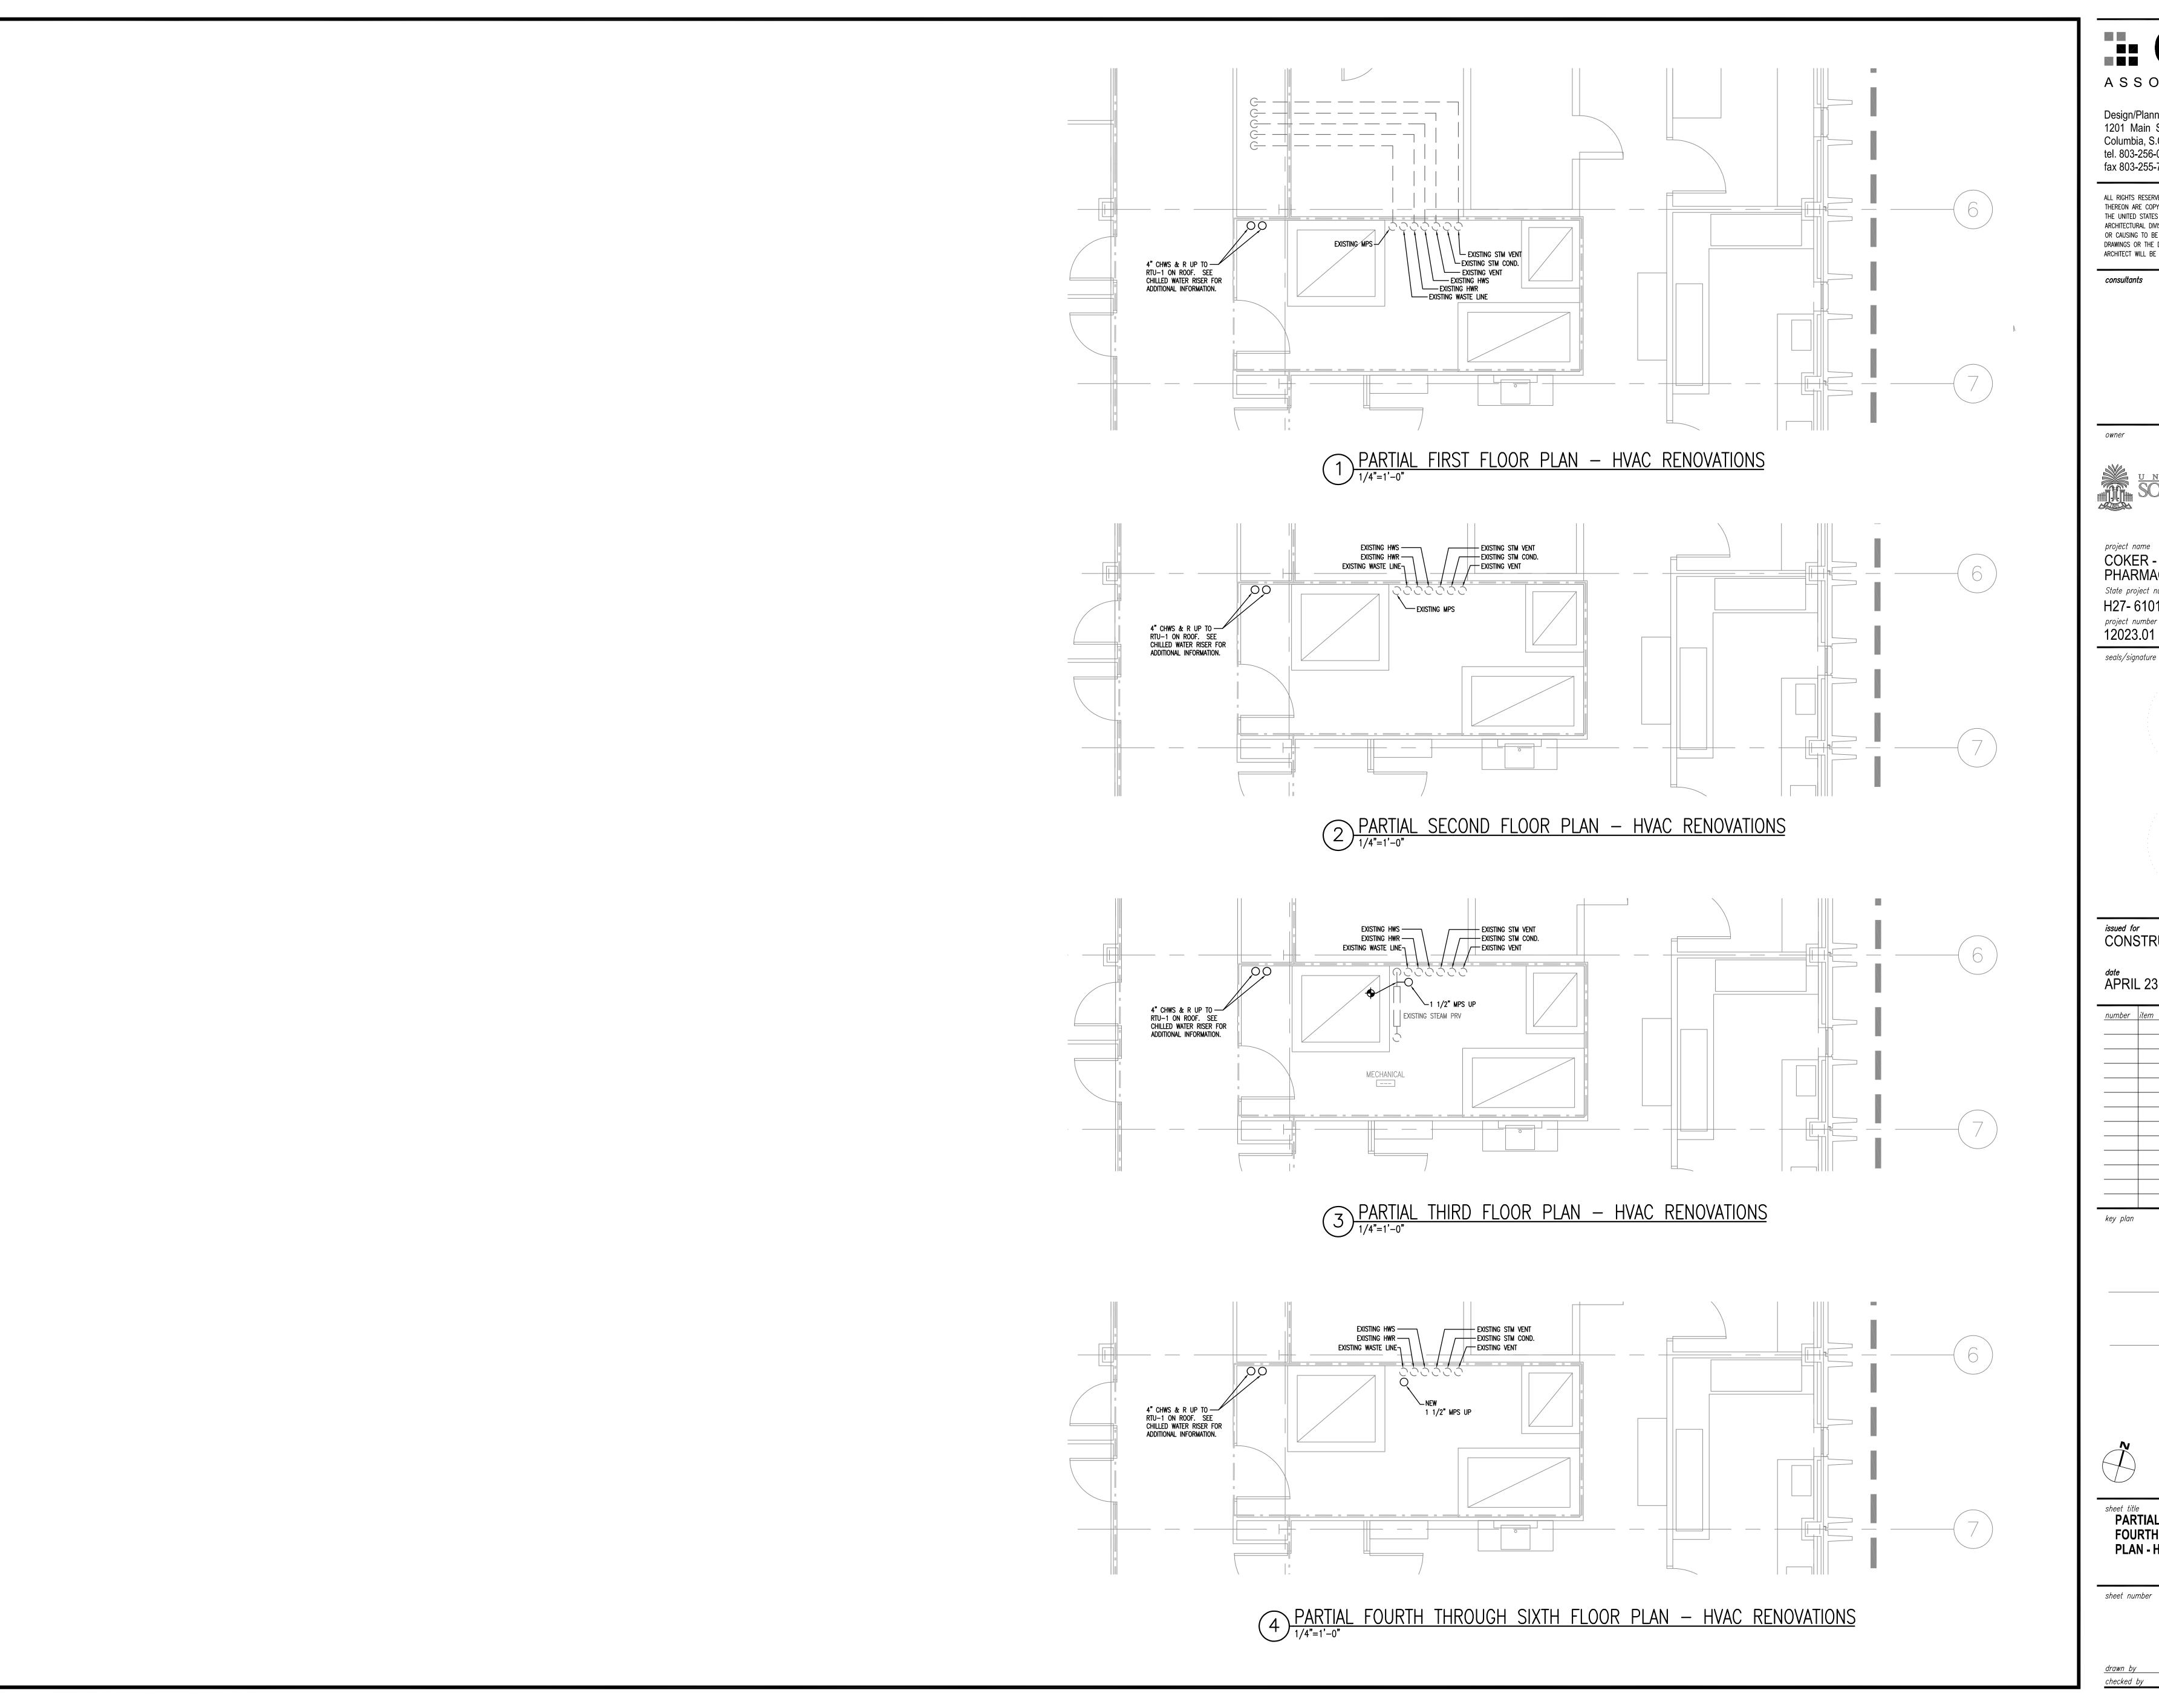
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sheet title
PARTIAL BASEMENT FLOOR PLAN
HVAC RENOVATIONS

sheet number



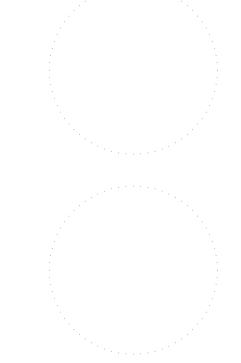
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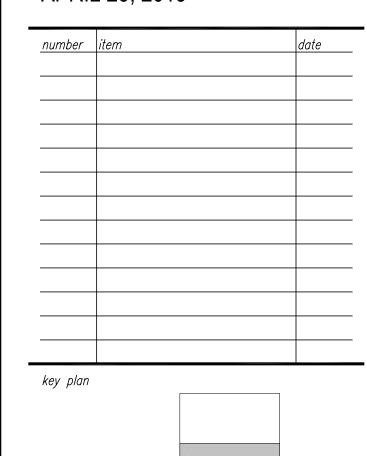
project name COKER - 7th FLOOR PHARMACY RENOVATION State project number H27- 6101 project number

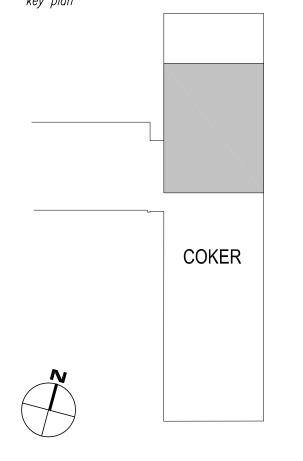
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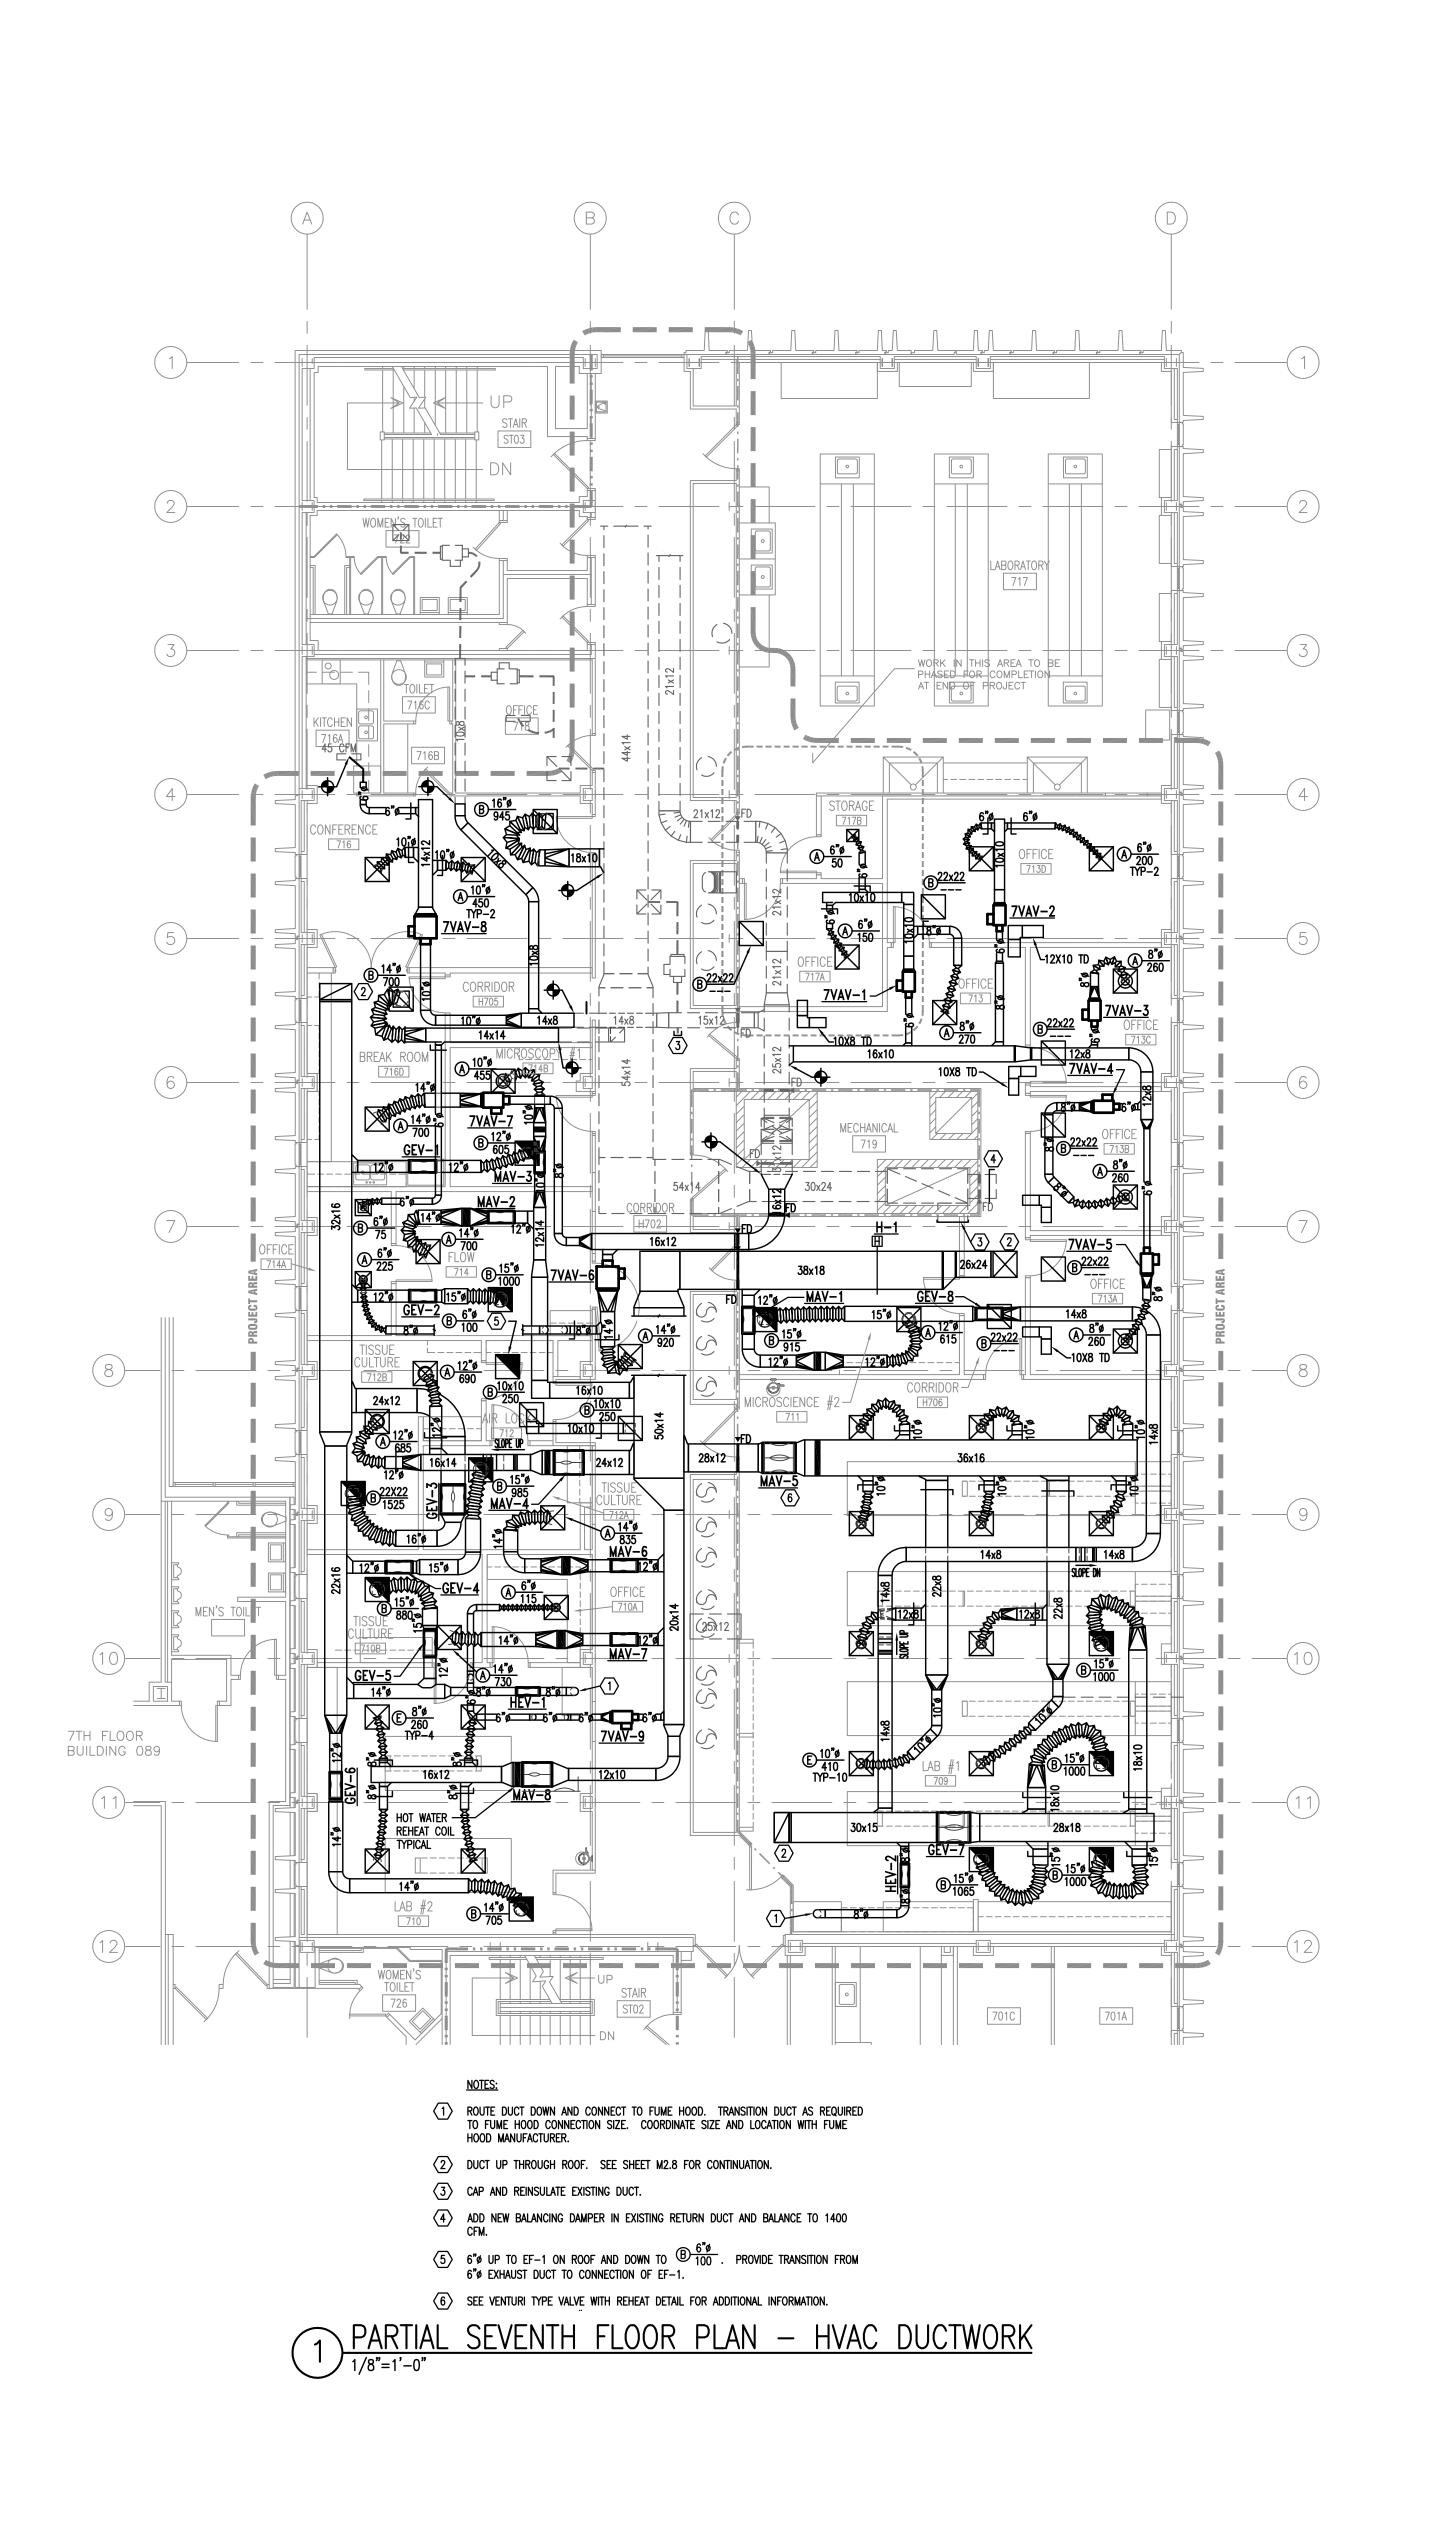





PARTIAL FIRST, SECOND, THIRD, FOURTH, FIFTH, & SIXTH FLOOR PLAN - HVAC RENOVATIONS

sheet number

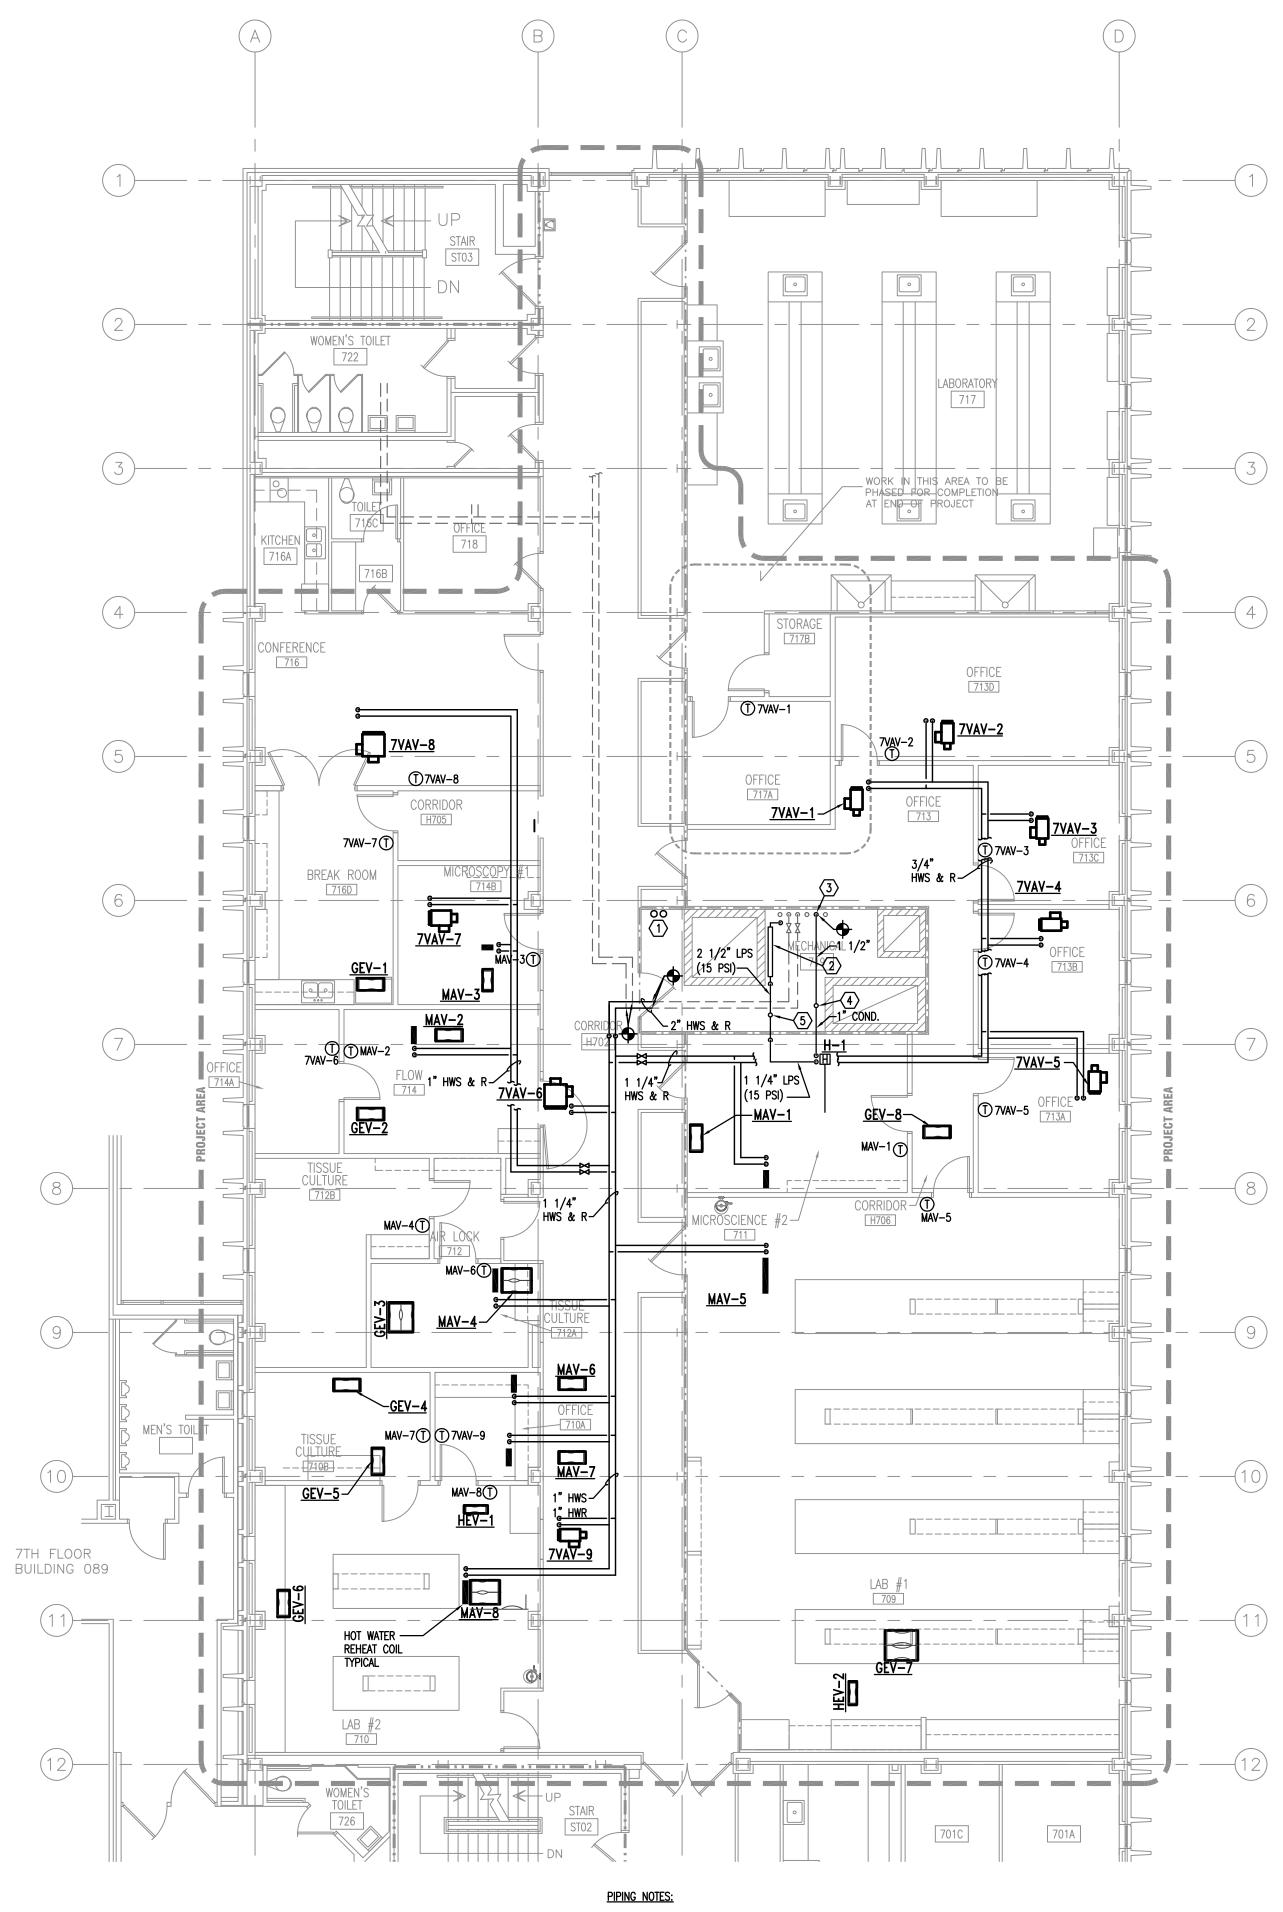M2.1





PIPING NOTES:

1 4" CHWS & R UP TO ROOF. SEE ROOF PLAN FOR CONTINUATION.

- NEW STEAM PRESSURE REDUCING STATION. SEE STEAM PRESSURE REDUCING STATION DETAIL ON SHEET M6.3 FOR ADDITIONAL INFORMATION.
- 1 1/2" CONDENSATE DOWN. SEE PARTIAL MECHANICAL ROOM PLANS FOR
- 1 1/2" CONDENSATE DOWN. SEE PARTIAL MECHANICAL ROOM PLANS FOR CONTINUATION.
 1 1/2" CONDENSATE UP TO ROOF. SEE SHEET M2.8 FOR CONTINUATION.
- (5) 2" LPS (15 PSI) UP TO ROOF. SEE SHEET M2.8 FOR CONTINUATION.
- 2 PARTIAL SEVENTH FLOOR PLAN HVAC PIPING 1/8"=1'-0"

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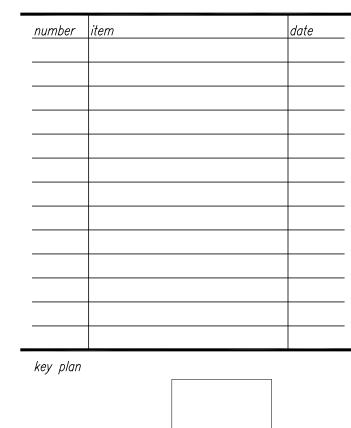


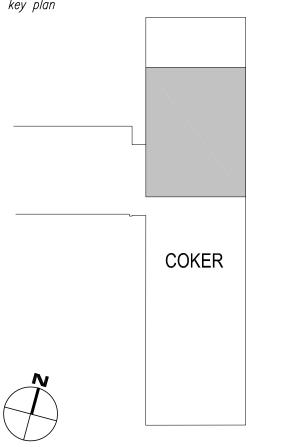
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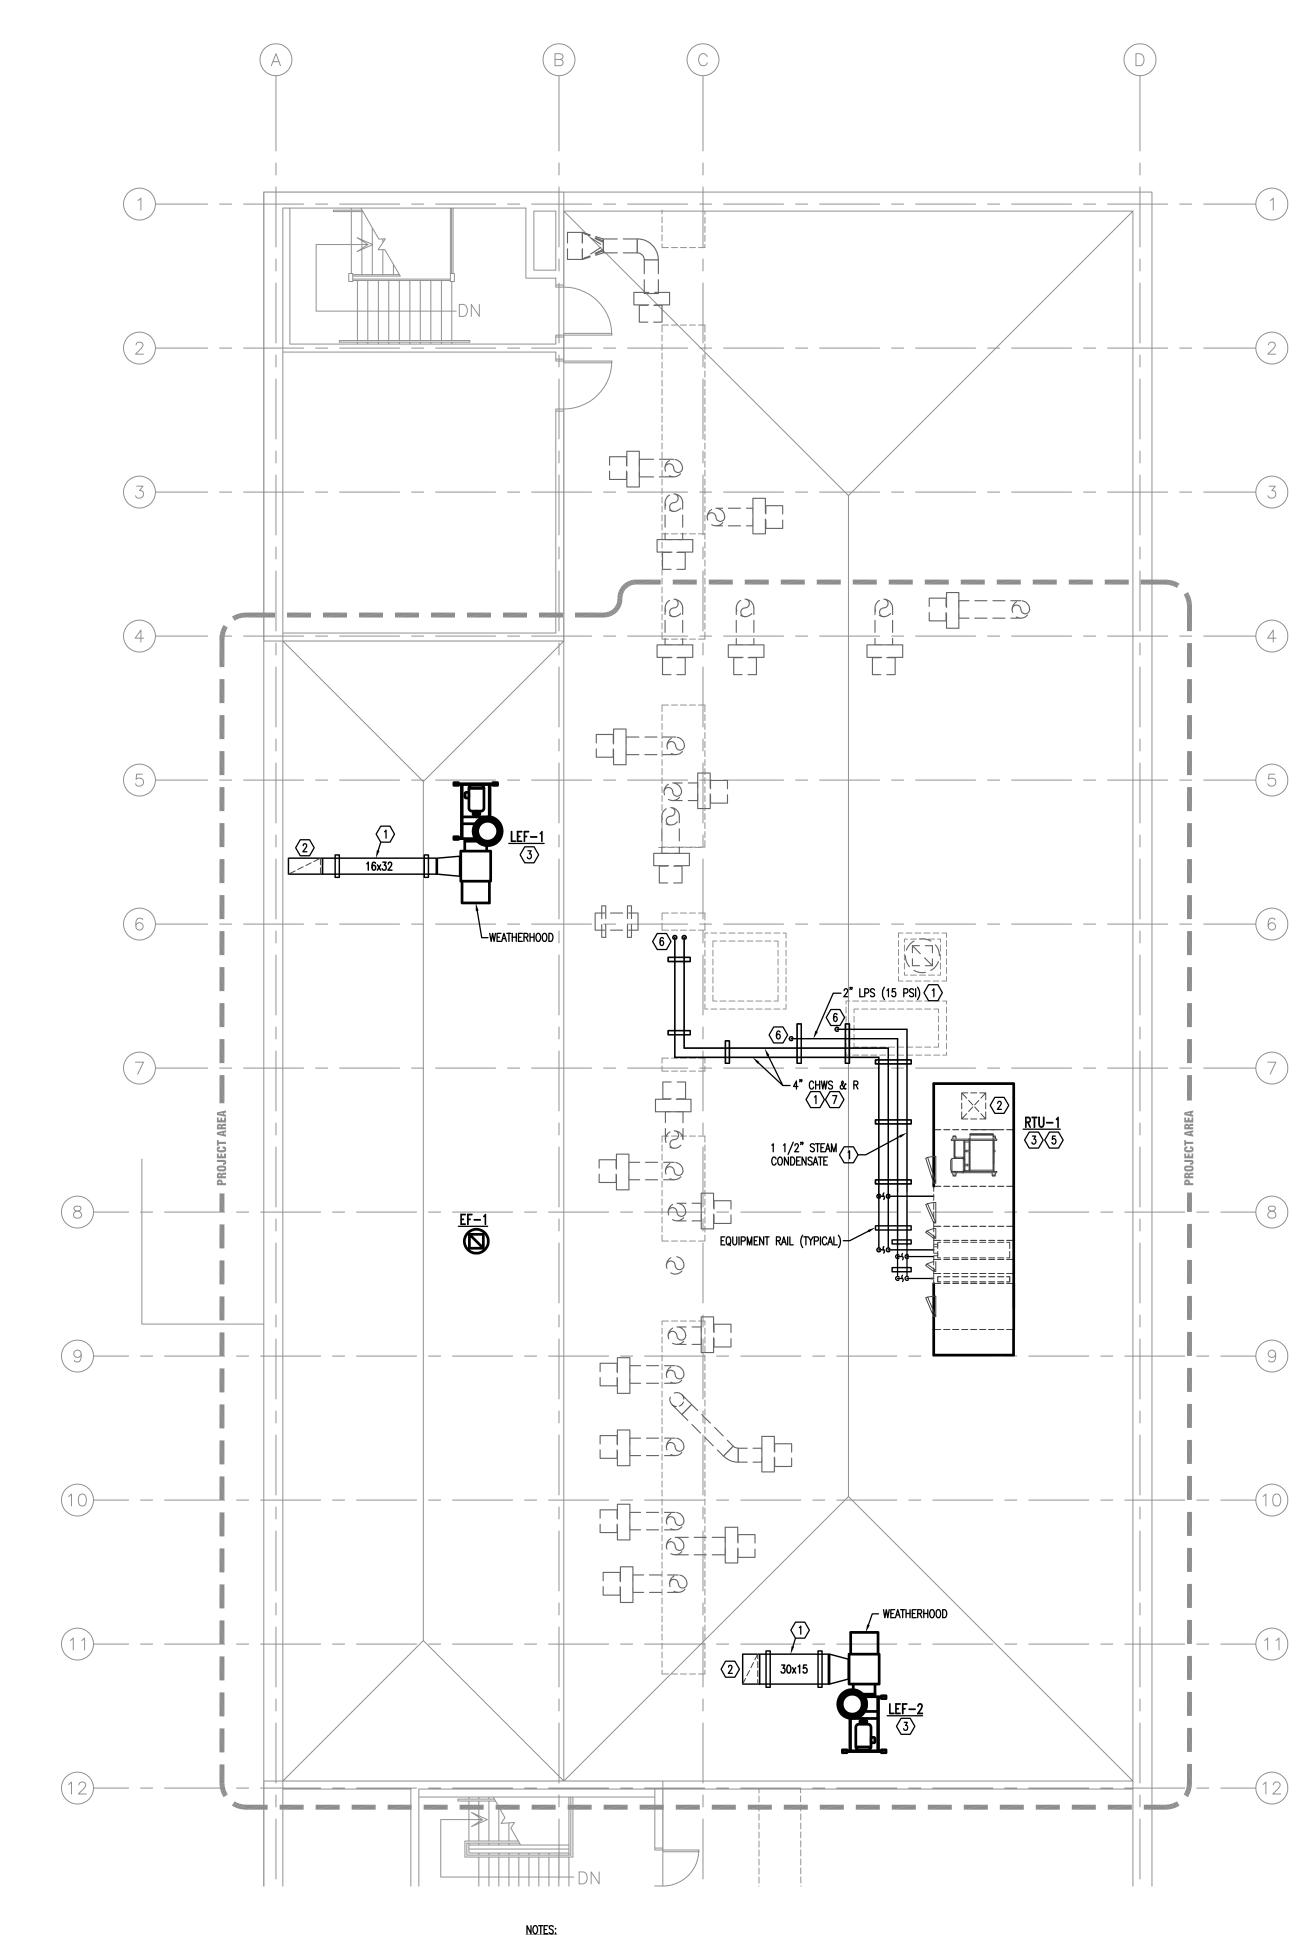




sheet title
PARTIAL SEVENTH FLOOR PLAN
HVAC DUCTWORK AND PIPING

sheet number

M2.7



INSTALL DUCTWORK AND PIPING ON EQUIPMENT RAILS. SEE EQUIPMENT RAIL DETAIL FOR ADDITIONAL INFORMATION.

DUCT DOWN THROUGH ROOF. SEE SHEET M2.7 FOR CONTINUATION. SEE ROOF FLASHING DETAILS FOR ADDITINAL INFORMATION.

3 INSTALL EXHAUST FAN ON STRUCTURAL SUPPORT. SEE STRUCTURAL DRAWINGS FOR ADDITIONAL INFORMATION. CONTRACTOR SHALL PROVIDE SUPPLEMENTAL SUPPORT TO SUPPORT FAN IN ACCORANCE WITH MANUFACTURER'S INSTRUCTIONS. SEE LAB EXHAUST FAN DETAIL FOR ADDITIONAL INFORMATION.

(4) INSTALL ROOFTOP UNIT ON STRUCTURAL SUPPORT. SEE STRUCTURAL DRAWINGS FOR ADDITIONAL INFORMATION.

PROVIDE DEEP SEAL P-TRAP FULL SIZE OF UNIT CONNECTION AND ROUTE CONDENSATE TO NEAREST ROOF DRAIN.

6 PIPING THROUGH ROOF. SEE SHEET M2.7 FOR CONTINUATION. SEE ROOF FLASHING DETAILS FOR ADDITIONAL INFORMATION.

PROVIDE HEAT TRACING ON CHILLED WATER PIPING. SEE DIVISION 16 DRAWINGS FOR CIRCUIT LOCATION. HEAT TRACING SHALL BE 5W/FT @ 120v/20A CIRCUIT.

1 PARTIAL ROOF PLAN — HVAC RENOVATIONS

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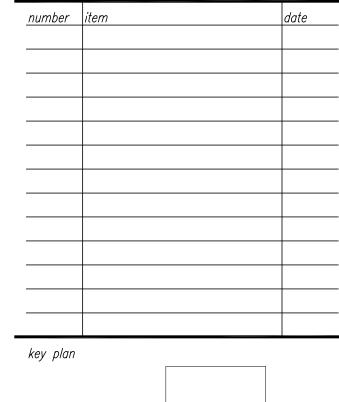


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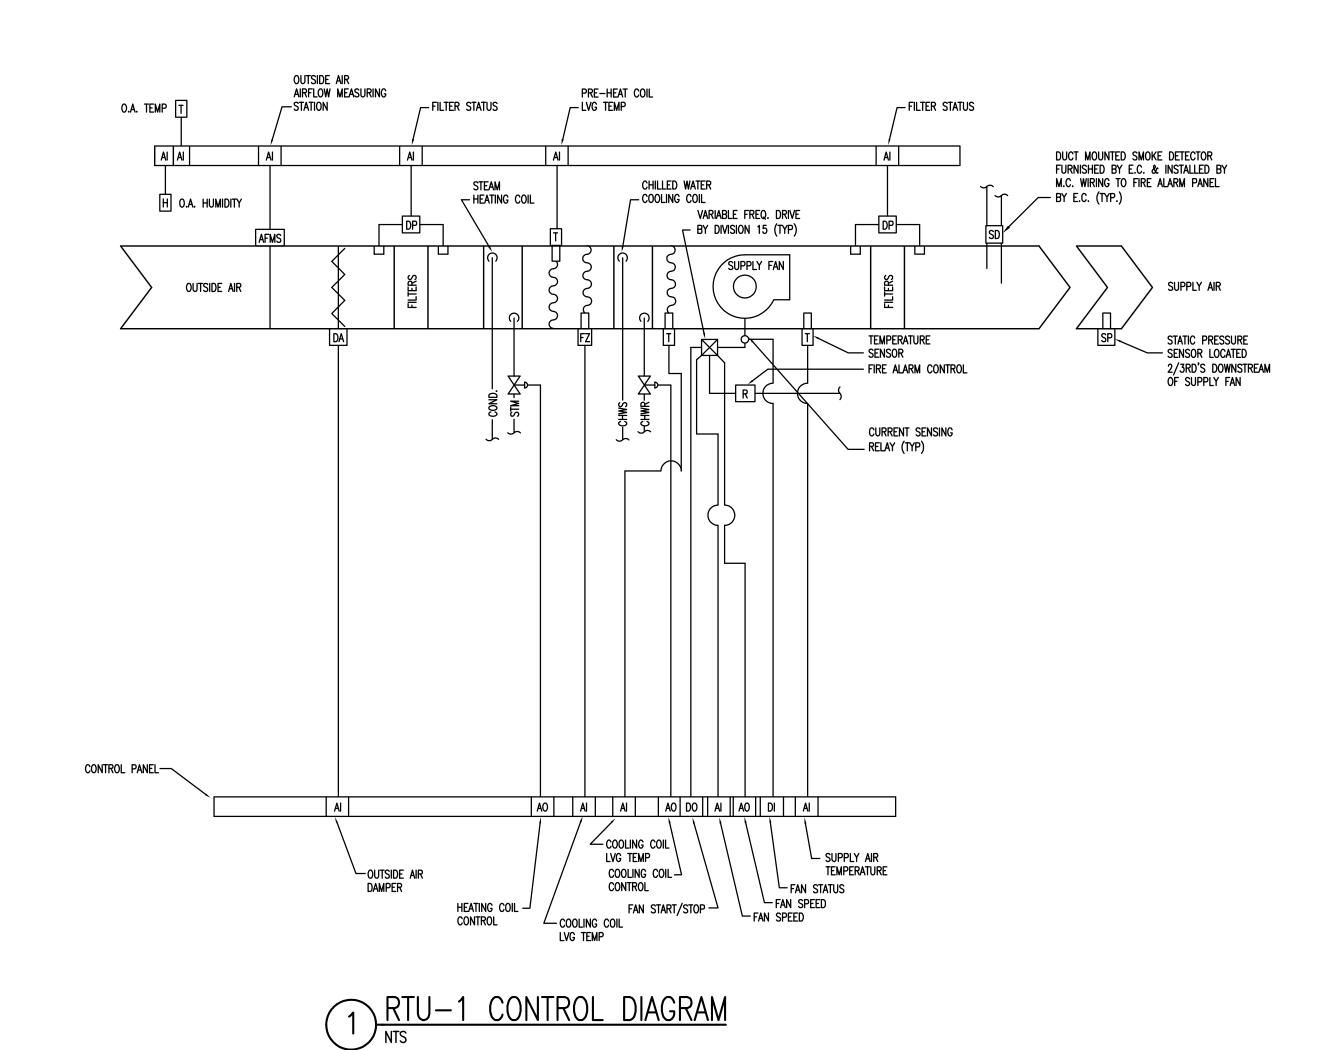



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PARTIAL ROOF PLAN -HVAC RENOVATIONS


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M2.





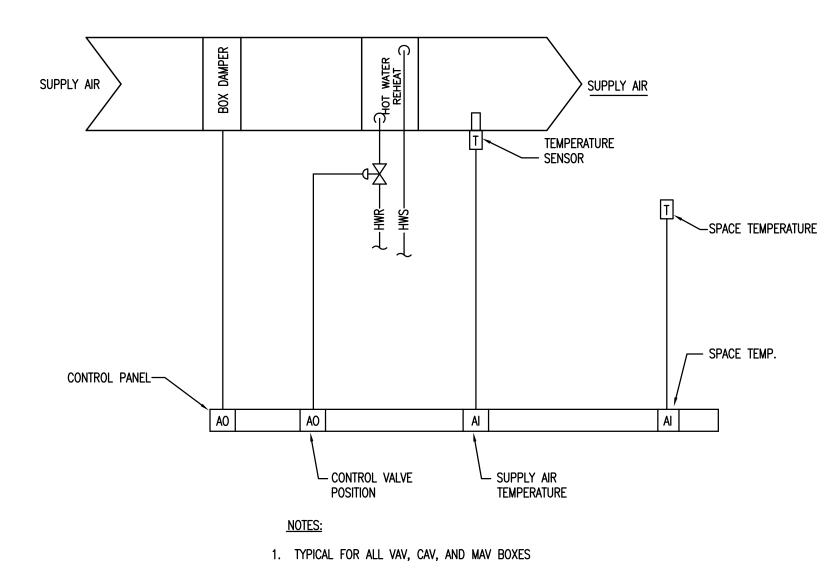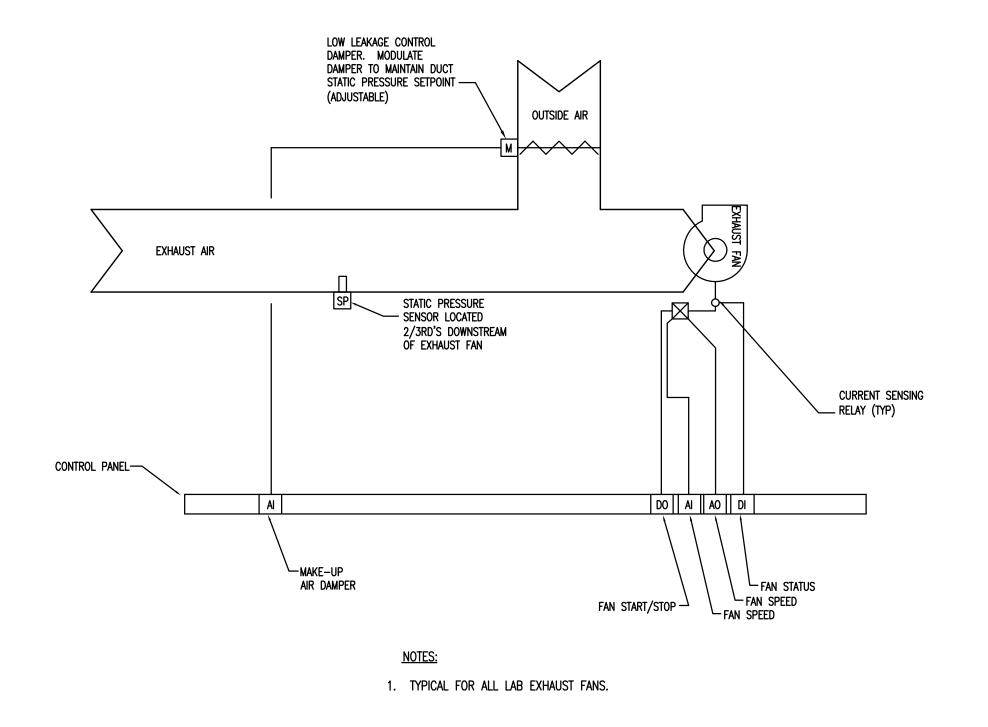2 TERMINAL BOX CONTROL DIAGRAM
NTS



3 LAB EXHAUST FAN CONTROL DIAGRAM



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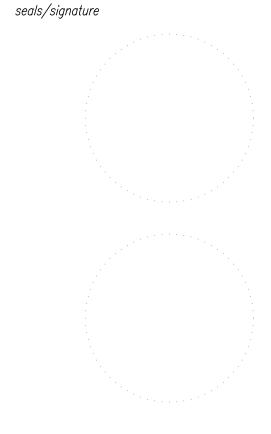
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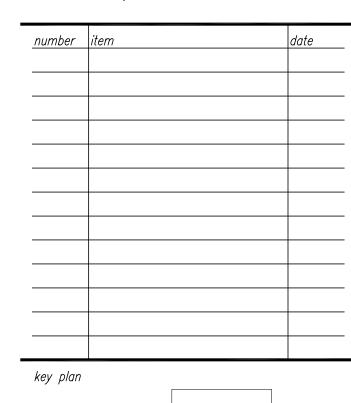
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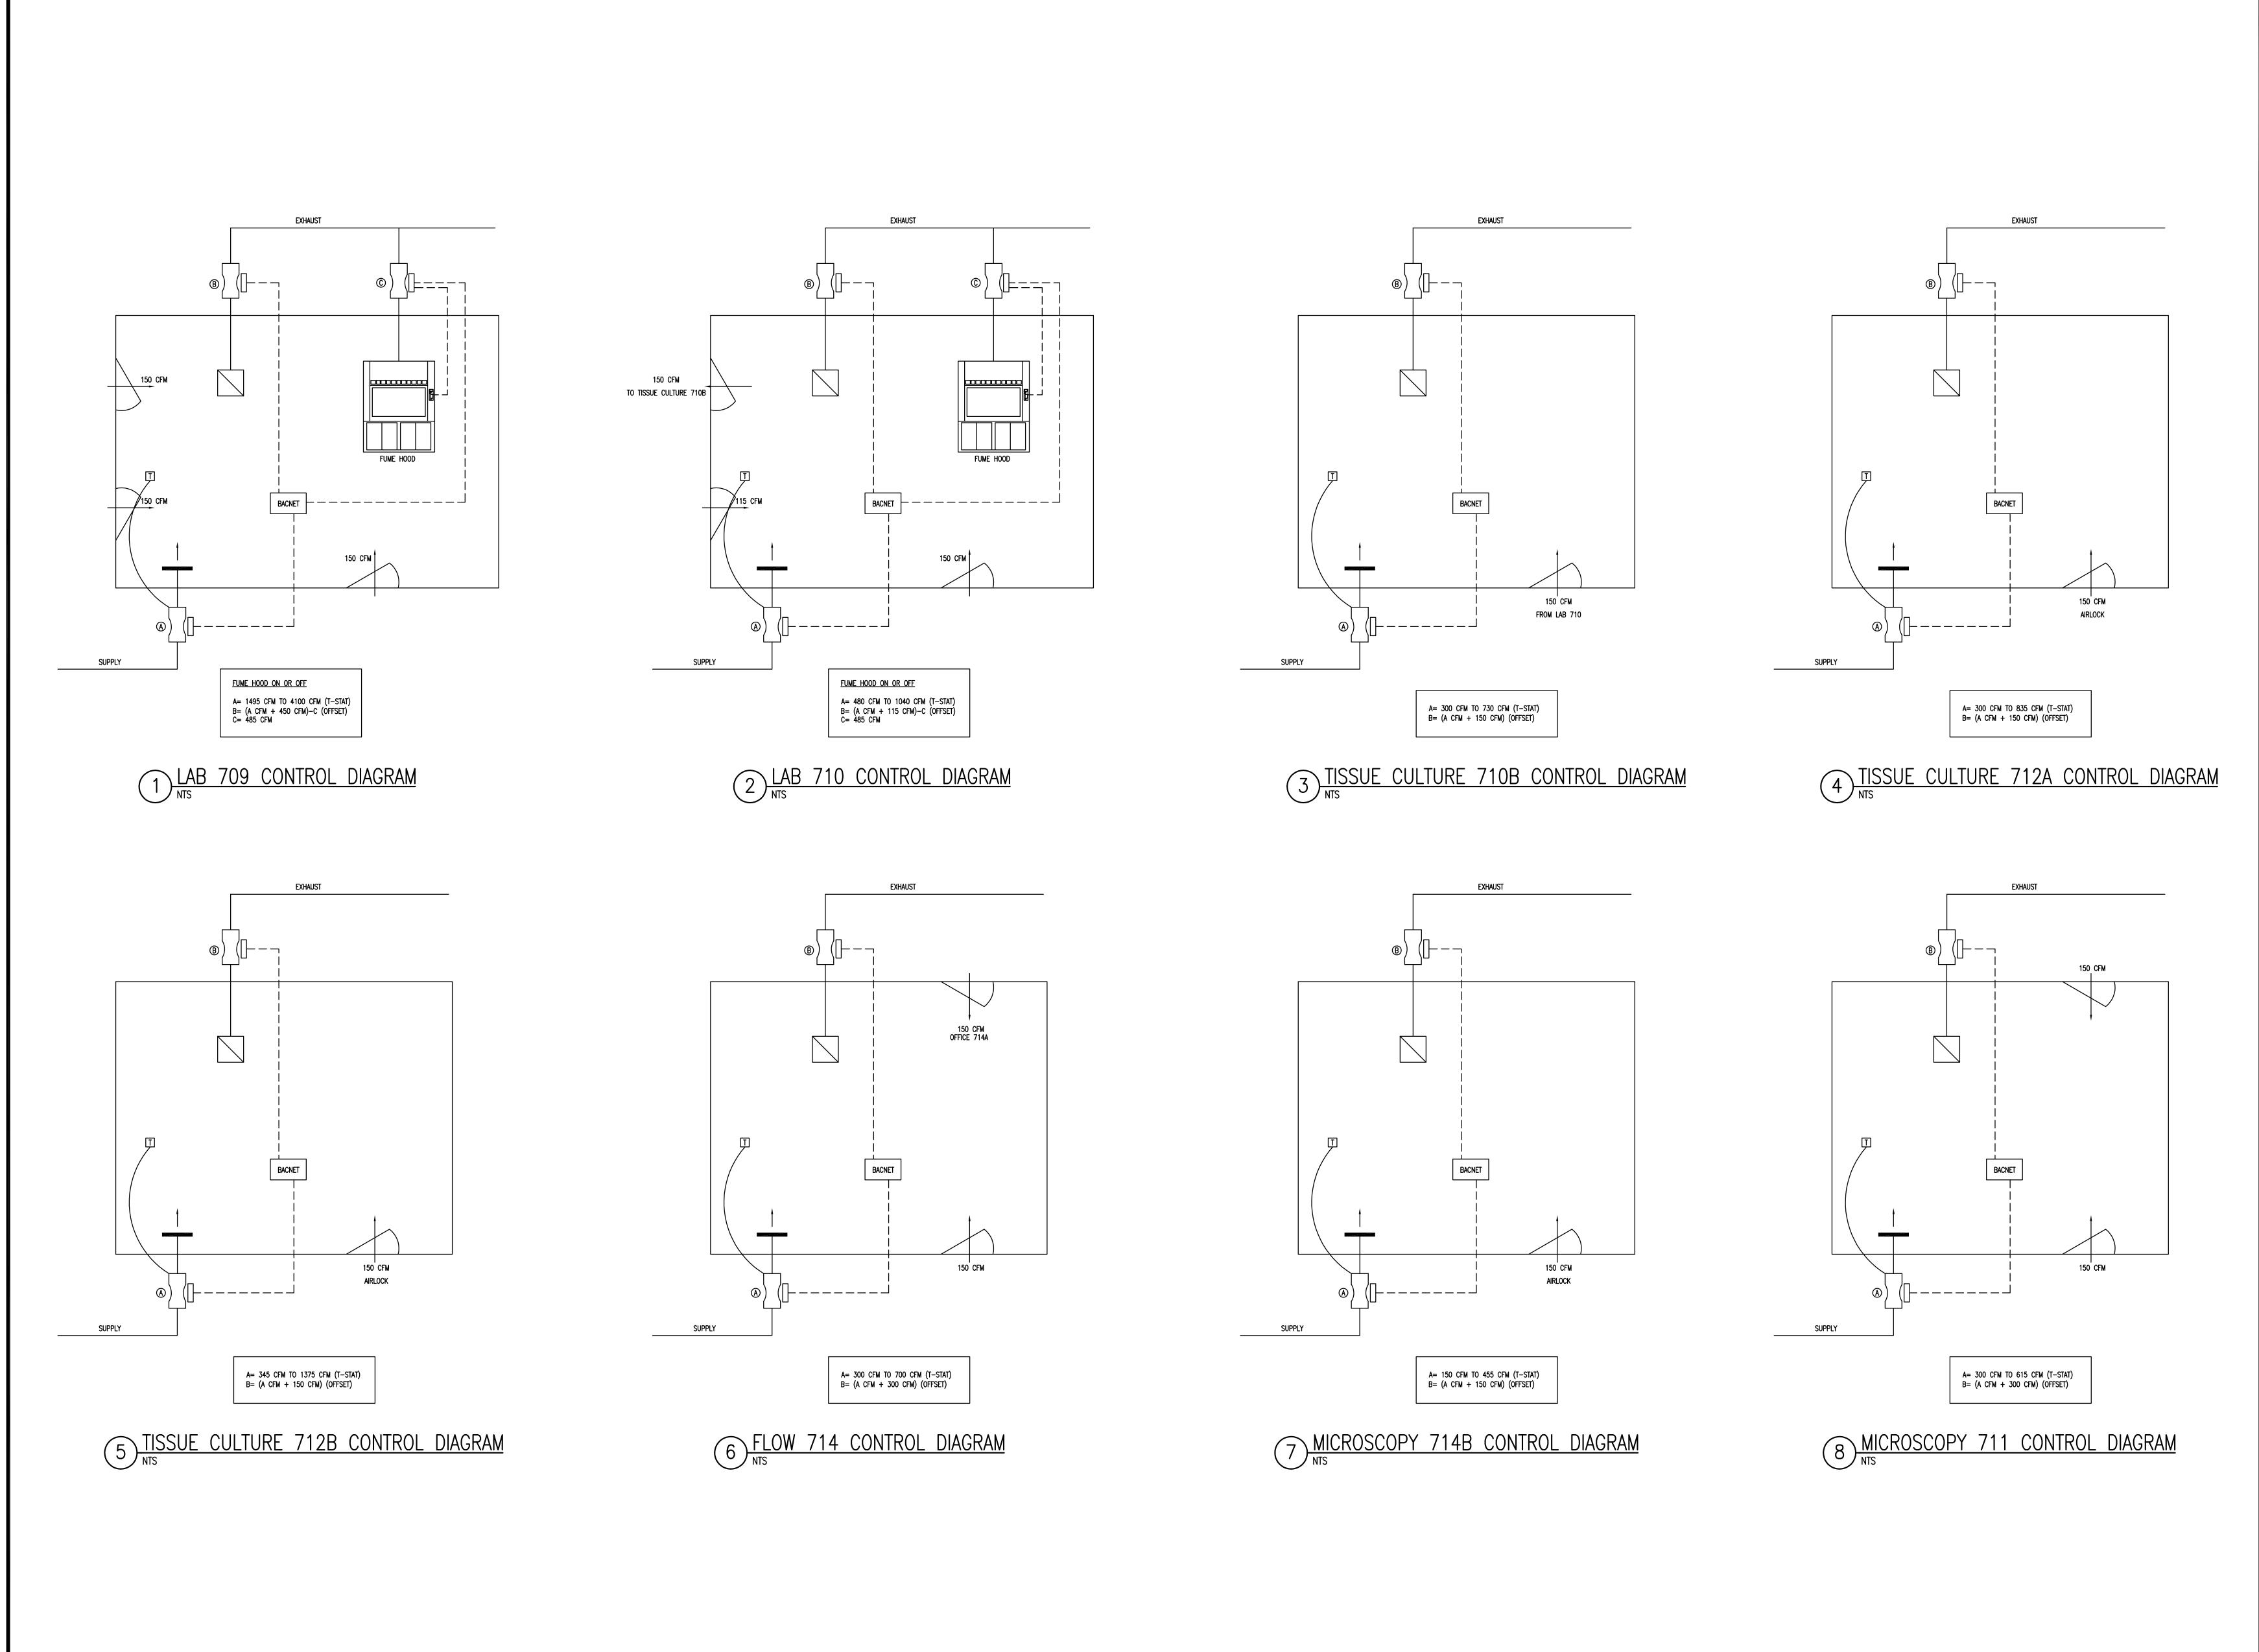
key plan

COKER

sheet title
HVAC CONTROL SCHEMATICS

sheet number

M5.1



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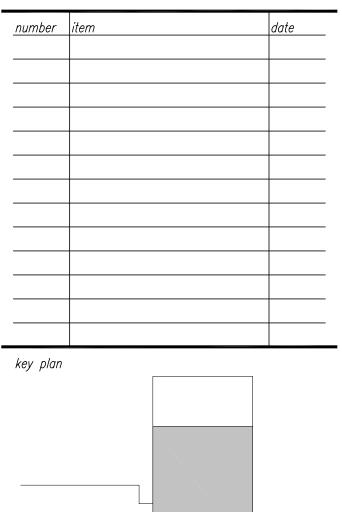


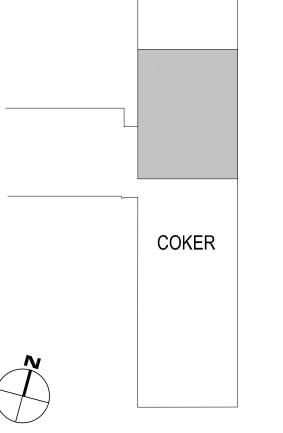
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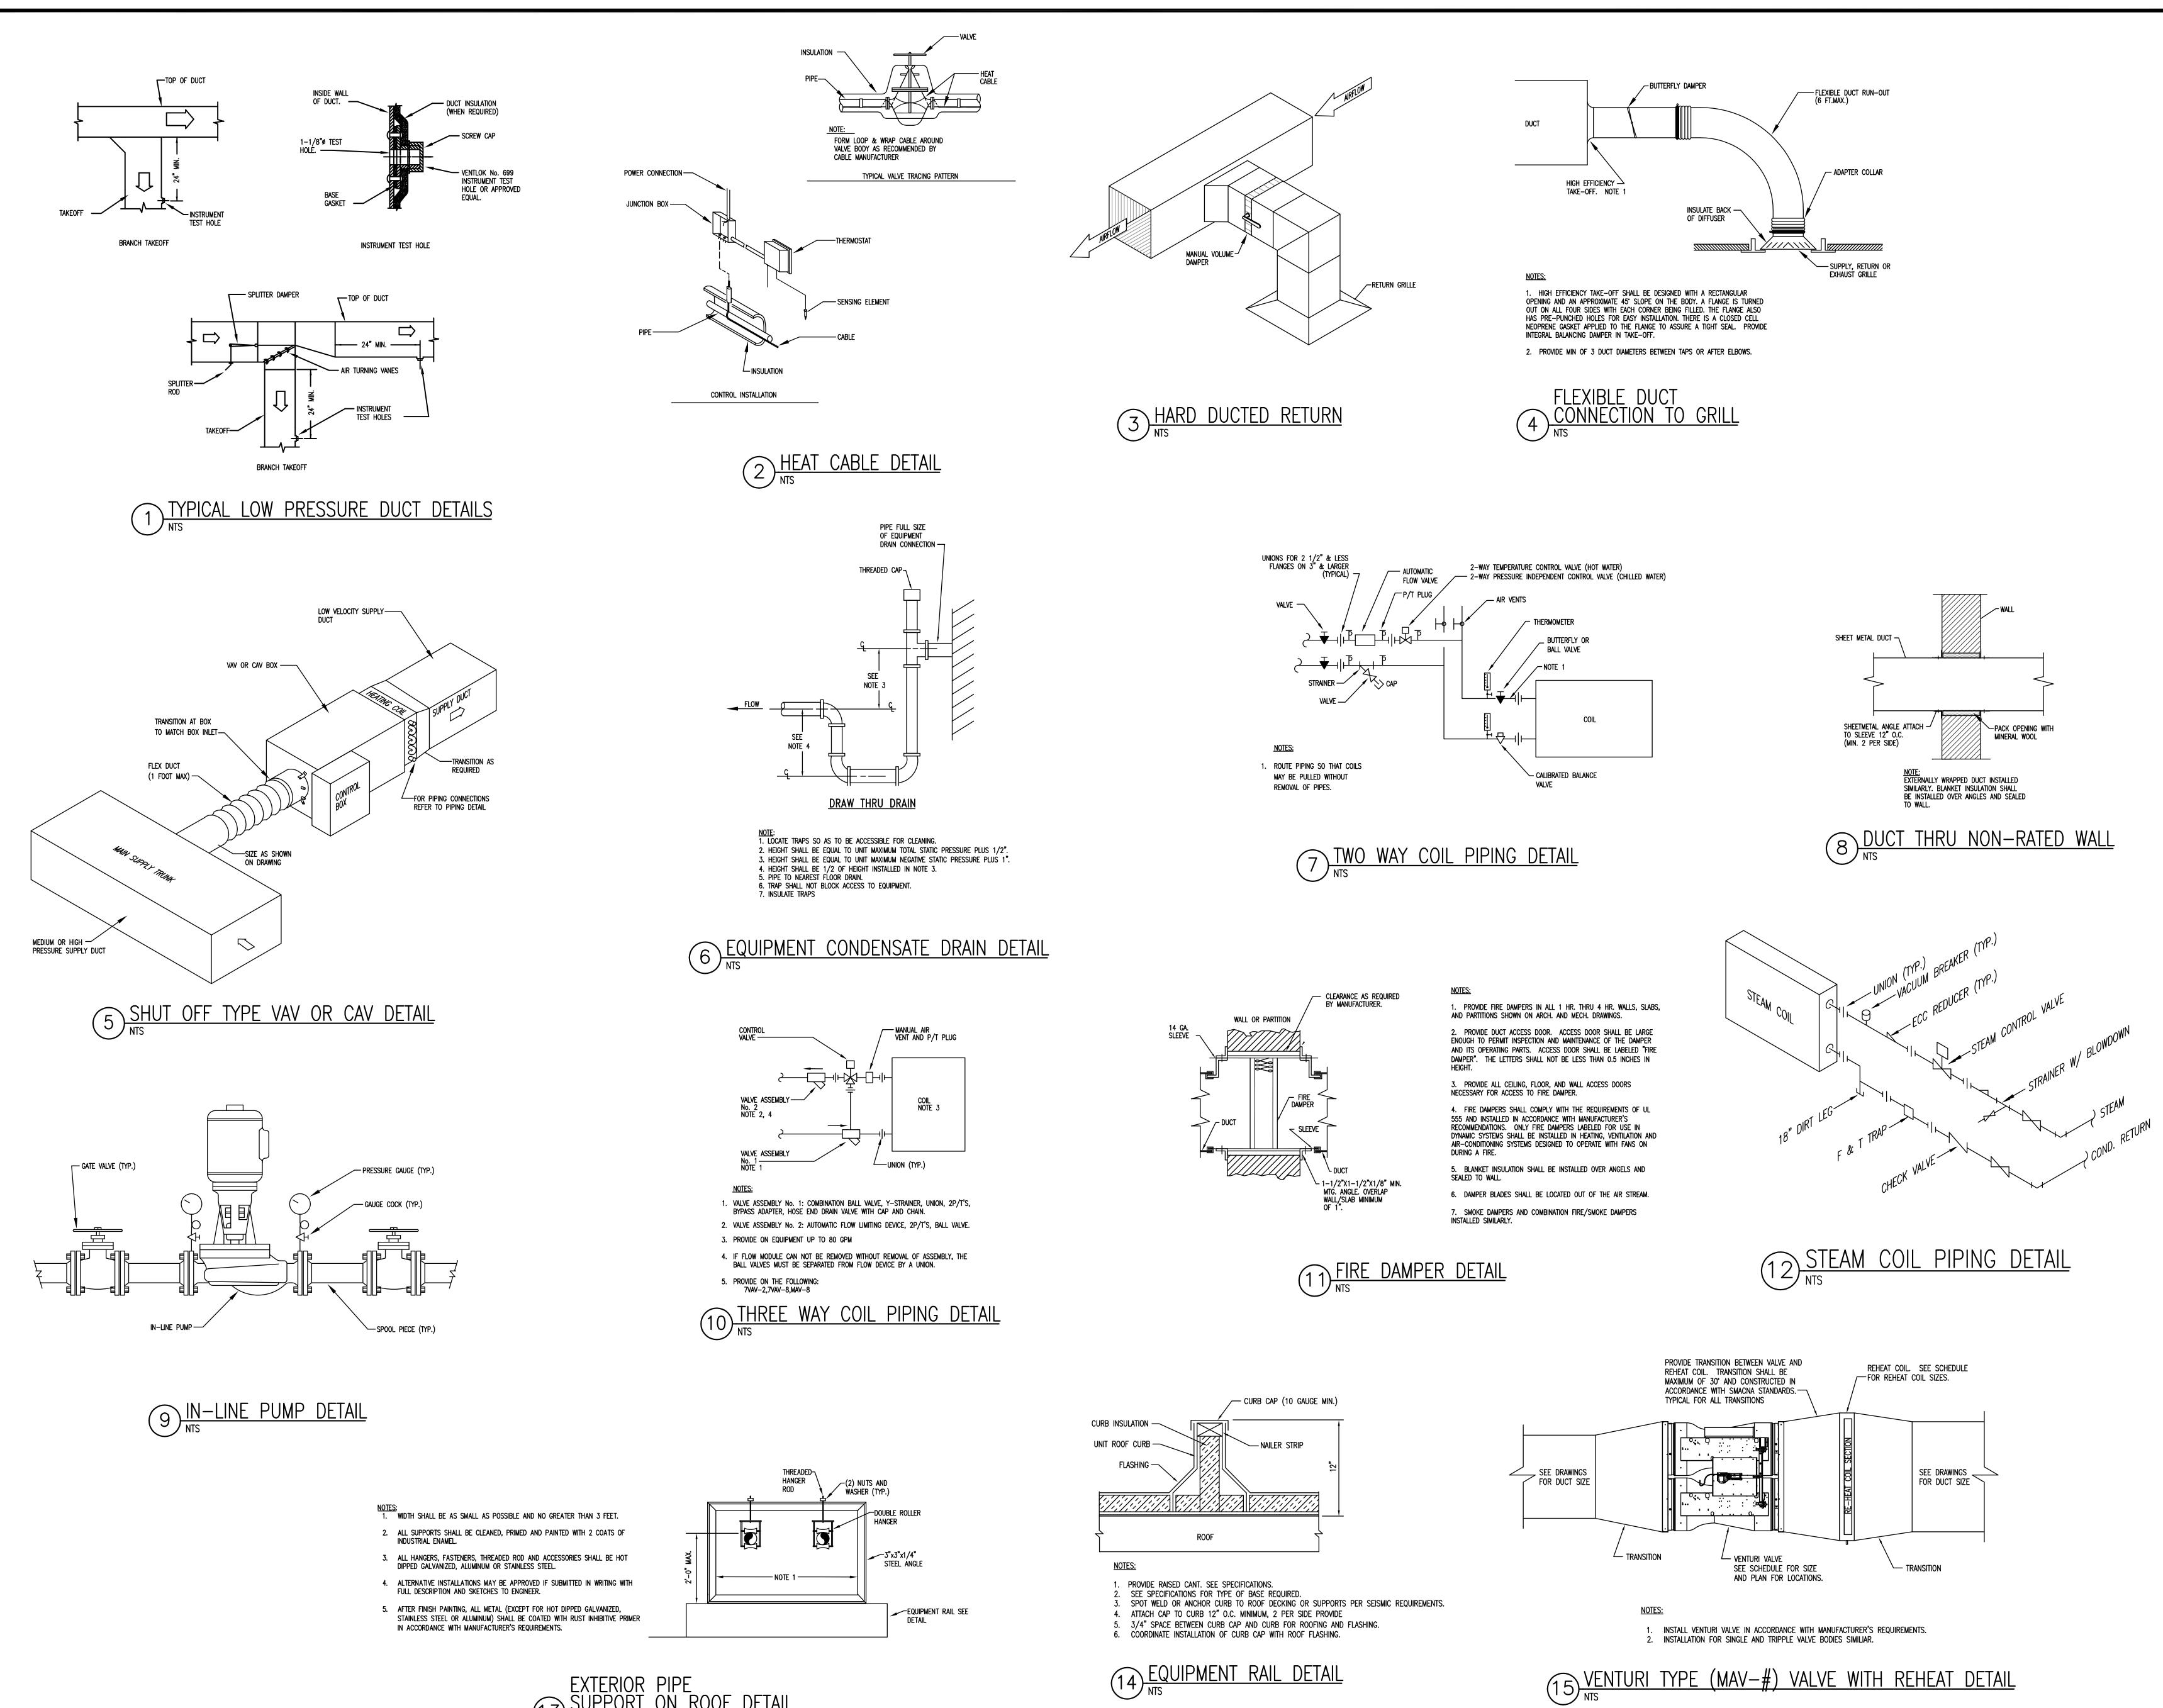




sheet title
HVAC CONTROL SCHEMATICS

sheet number

M5.2



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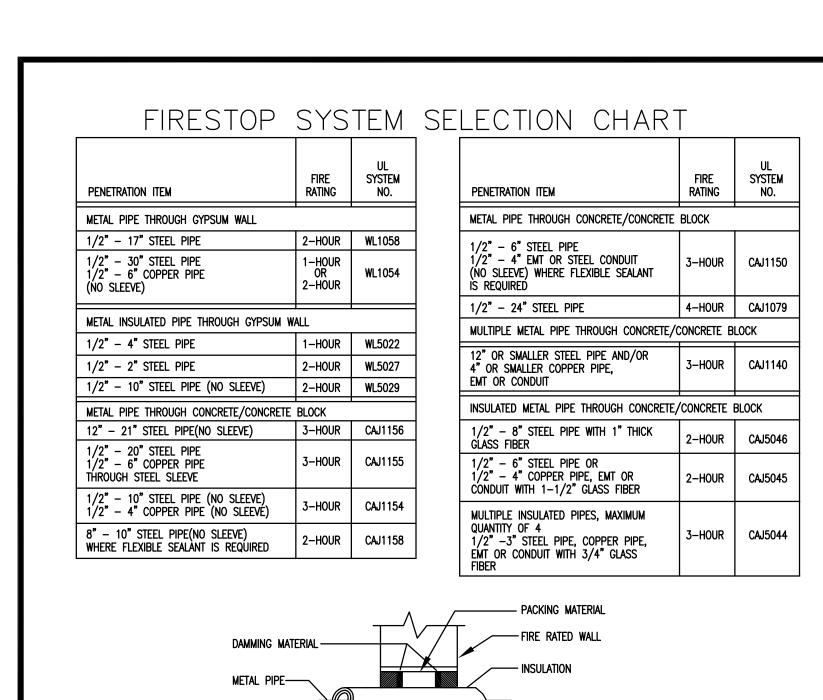
APRIL 23, 2013

key plan COKER

HVAC DETAILS

sheet number

drawn by JDR <u>checked</u> by **JDR**

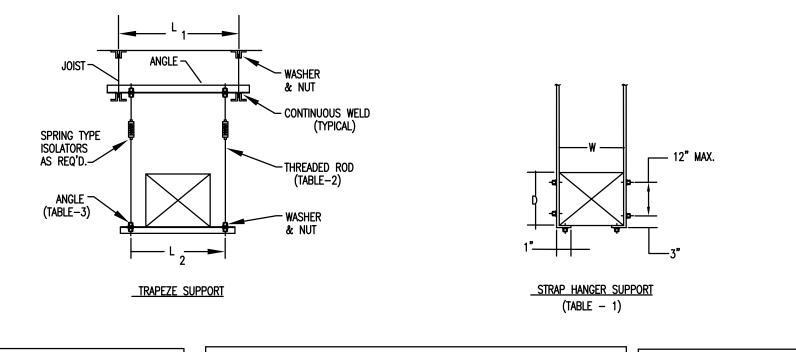


SCH. 40 STEEL ----

PIPE SLEEVE


EQUIPMENT SUPPORT —


SEE STRUCTURAL




			- L 2	<u> </u>	& NUT		1"	₹			
			TRAPEZE	<u>SUPF</u>	PORT		· · · · · · · · · · · · · · · · · · ·	<u>HANGER SUP</u> TABLE – 1)	<u>PORT</u>		
TABLE-	-1 STRAP HAN	NGERS (PAIR) S	SPACED		_TABL	<u>E-2</u> ALLOW	ABLE HANGER LOADS — MAX.			ABLE-3 TRAPEZE	ANGLE LOAD — MAX.
W + D MAX.	10'-0" MAX.	8'-0" MAX.	5'-0" OR LESS		STRAPS	LBS.	RODS	LBS.	L ₁ OR L ₂	2"x2"x1-1/4"	2-1/2"x2-1/2"x1/4"
72"	1" x 22Ga.	1" x 22Ga.	1" x 22Ga.		2 - 1"x22Ga.	520	2 – 1/4" DIA.	540	36"	1200 LBS.	1940 LBS.
96"		1" x 20Ga.	1" x 22Ga.		2 - 1"x20Ga.	640	2 - 3/8" DIA.	1360	48"	1160 LBS.	1900 LBS.
120"		1" x 18Ga.	1" x 22Ga.		2 - 1"x18Ga.	840	2 – 1/2" DIA.	2500	60"	1060 LBS.	1800 LBS.
168"			1" x 18Ga.		2 - 1"x16Ga.	1400	2 - 5/8" DIA.	4000	72"	900 LBS.	1640 LBS.
192"			1" x 16Ga.				2 - 3/4" DIA.	6000	84"	660 LBS.	1400 LBS.

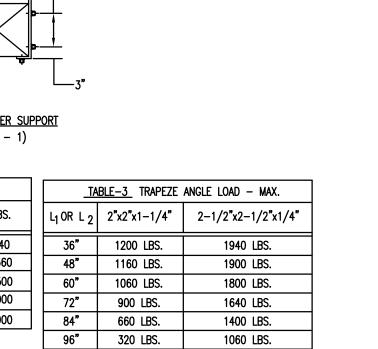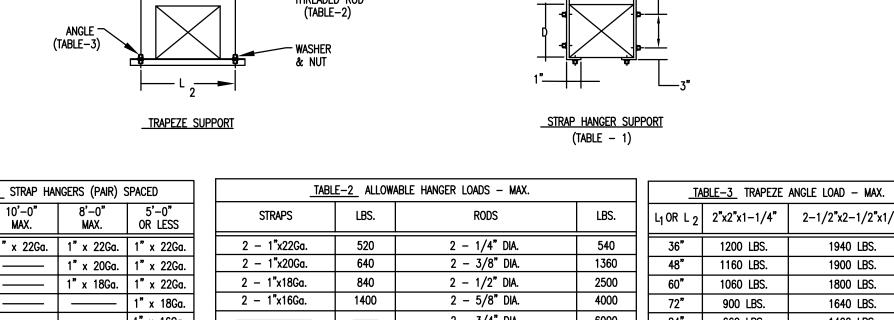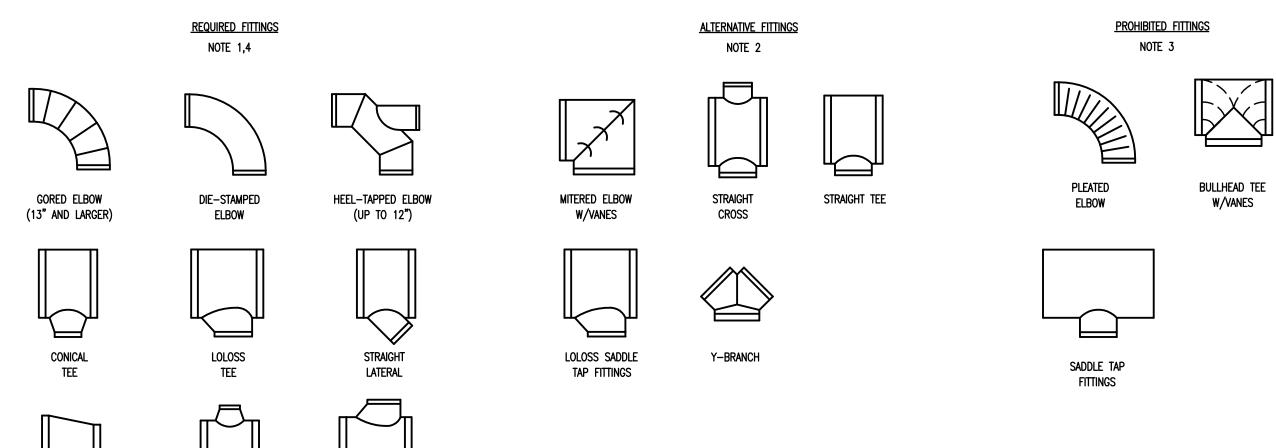2 DUCT AND EQUIPMENT SUPPORT DETAILS








NOTES: 1. REQUIRED FITTINGS ARE FITTINGS THAT SHALL BE INCLUDED IN BIDDING THE PROJECT.

- 2. ALTERNATIVE FITTINGS ARE FITTINGS THAT MAY BE CONSIDERED BY THE A/E IF IT IS DETERMINED THAT PHYSICAL CONSTRAINTS MAKE A FITTING IN THIS GROUP A BETTER ALTERNATIVE TO THE REQUIRED FITTING. THESE FITTINGS WILL ONLY BE CONSIDERED BY THE A/E UPON REVIEW OF COORDINATION DRAWINGS OR SKETCHES SUBMITTED BY THE CONTRACTOR.
- 3. PROHIBITED FITTINGS INCLUDE THOSE INDICATED PLUS ANY OTHERS NOT INDICATED ON THIS
- 4. ALL RADIUS SHALL BE 1 1/2"R.

TAPERED

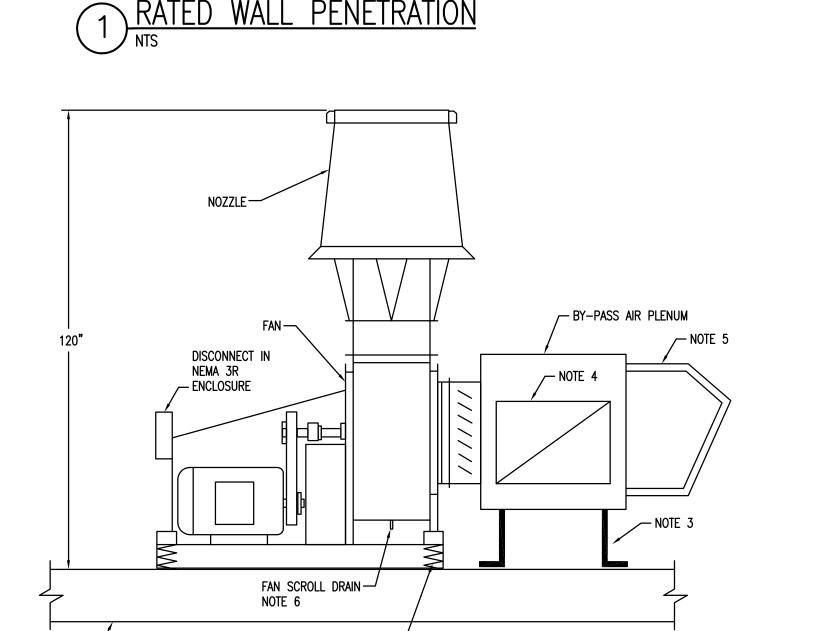Y-BRANCH




EACH SIDE OF WALL FLUSH


SEE FIRESTOP SYSTEM SLECTION CHART

TO EXTERIOR OF WALL.

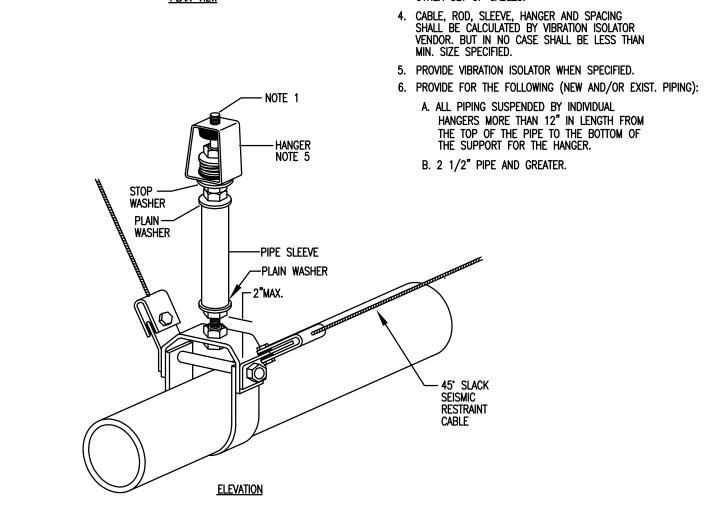
- <u>NOTES:</u> 1. CONTRACTOR SHALL PROVIDE SUPPLEMENT SUPPORTS AS REQUIRED TO SUPPORT EXHAUST FAN ON STRUCTURAL FRAME.
- INSTALL EXHAUST FAN IN ACCORDANCE WITH MANUFACTURER'S REQUIREMENTS. ATTACH PLENUM BOX TO STRUCTURAL SUPPORT. 4. DUCT CONNECTION TO PLENUM BOX. SEE PLAN FOR ADDITIONAL INFORMATION
- ON LOCATION OF DUCT CONNECTION. WEATHERHOOD WITH BYPASS DAMPER. SEE PLAN FOR ADDITIONAL INFORMATION ON LOCATION OF MAKE-UP AIR HOOD. 6. PROVIDE P-TRAPS AT EACH DRAIN CONNECTION AND ROUTE DRAIN TO NEAREST
- ROOF DRAIN. EXHAUST FAN HAS MULITPLE LOCATIONS FOR DRAIN CONNECTIONS, ONE ON EACH PLENUM SECTION, AND ANOTHER ON EACH TUBLAR FAN HOUSING LOCATED AT THE BOTTOM OF THE SCROLL.



1. ATTACH ROD TO STRUCTURE, PROVIDE 1/4" CLEARANCE BETWEEN STRUCTURE AND TOP OF ISOLATOR OF NUT.

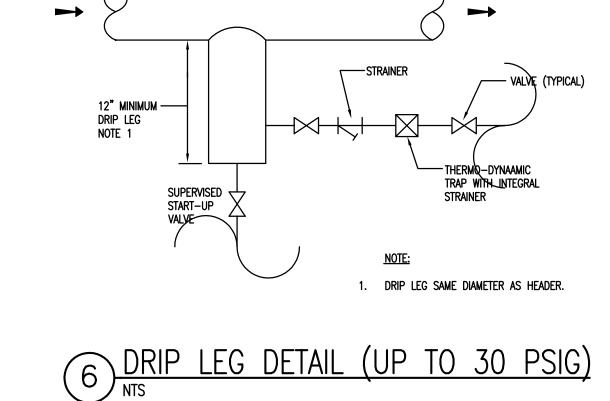


SQUARE-TO-

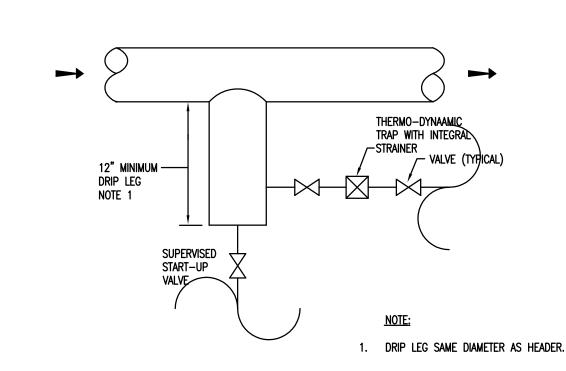


7) DRIP LEG DETAIL (30 PSIG AND ABOVE)


4 LAB EXHAUST FAN DETAIL

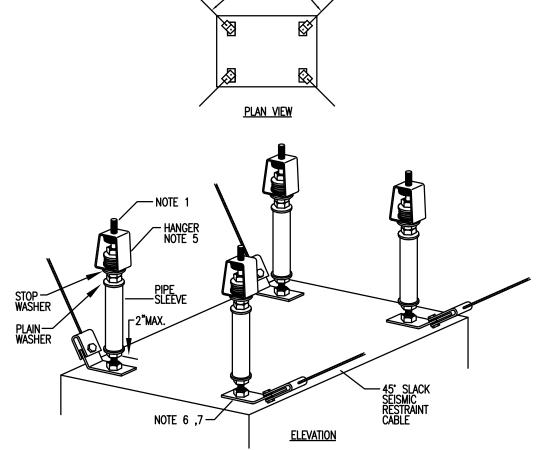SPRING ISOLATORS. SEE SPECIFICATIONS —





- ATTACH ROD TO STRUCTURE. PROVIDE 1/4" CLEARANCE BETWEEN STRUCTURE AND TOP OF ISOLATOR OR NUT. PROVIDE TWO NUTS WITH 1/8" CLEARANCE BETWEEN BOTTOM OF ISOLATOR AND WASHER.
- CABLE SHALL BE AT 45 DEGREES FROM UNIT AND CEILING. ALTERNATE DIRECTIONS EVERY OTHER SET OF CABLES. CABLE, ROD, SLEEVE, HANGER AND SPACING SHALL BE CALCULATED BY VIBRATION ISOLATOR VENDOR. BUT IN NO CASE SHALL BE LESS THAN MIN. SIZE SPECIFIED.
- 5. PROVIDE VIBRATION ISOLATOR WHEN SPECIFIED. 6. PROVIDE TWO NUTS ON INTERIOR OF UNIT. 7. EQUIPMENT MAY BE TRAPEZE MOUNTED. TRAPEZE SHALL BE SECURED TO UNIT.
- 8 SUSPENDED EQUIPMENT SEISMIC DETAIL

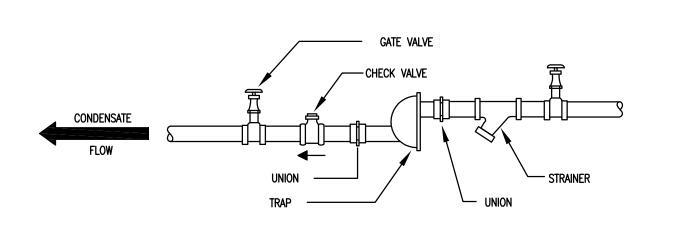

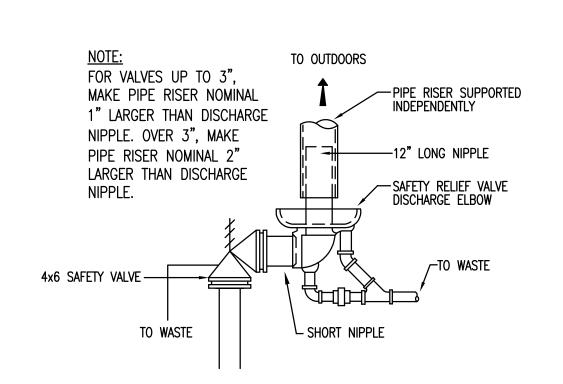

SAFETY STEAM RELIEF VALVE DETAIL

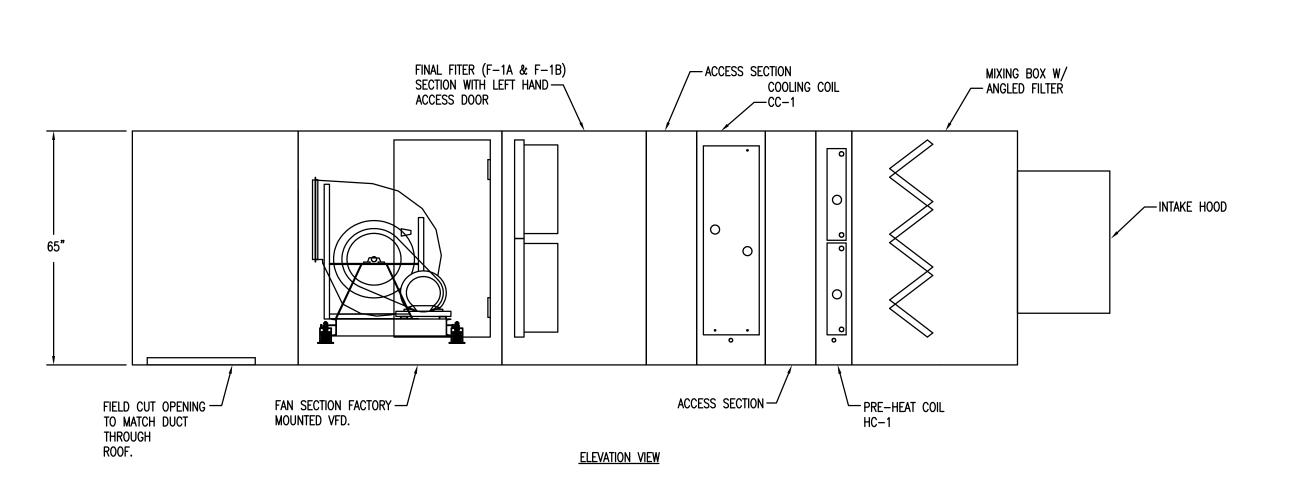

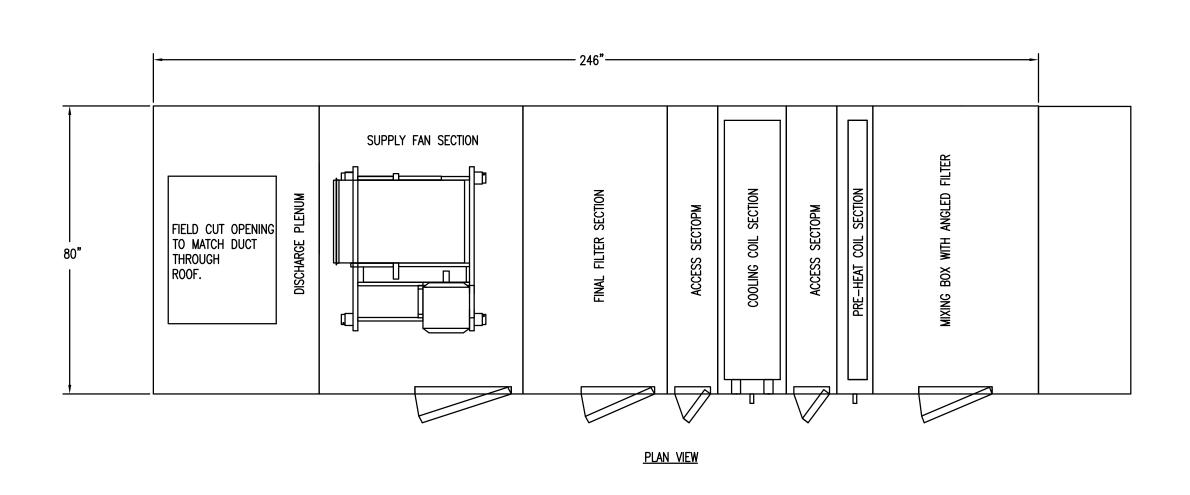

11 RTU-1 UNIT CONFIGURATION DETAIL

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Columbia, S.C. 29201

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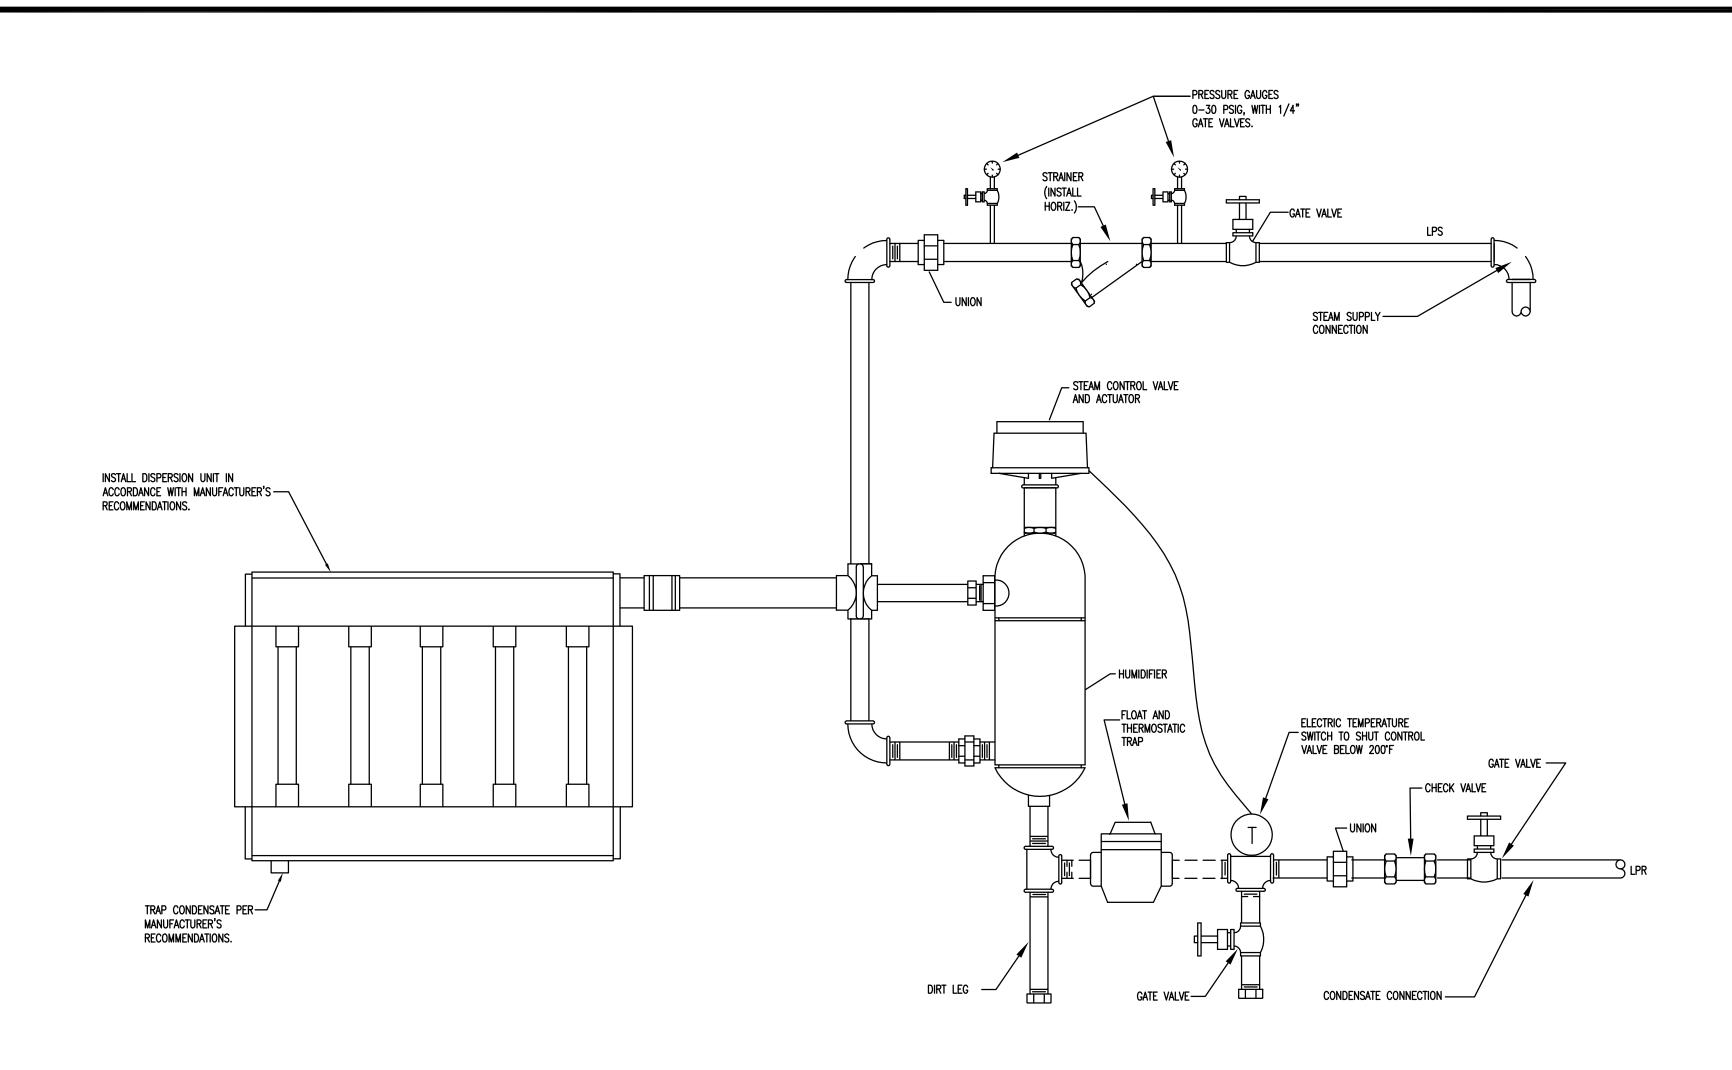
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PHARMACY RENOVATION


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HVAC DETAILS

sheet number M6.2



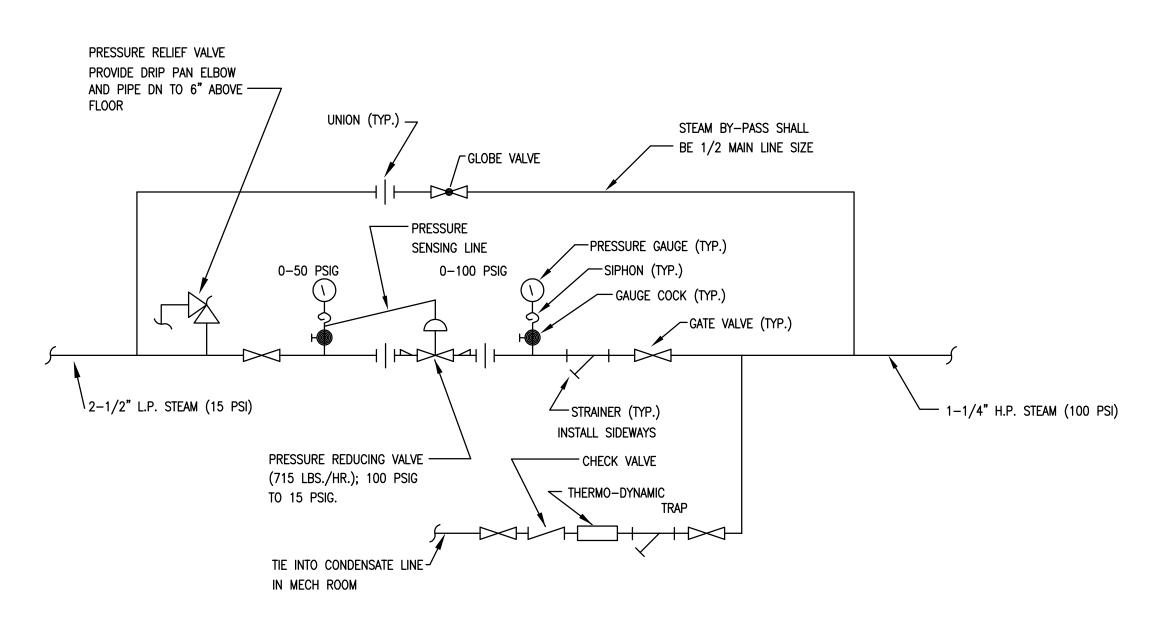1 STEAM HUMIDIFIER DETAIL



2 STEAM PRESSURE REDUCING DETAIL

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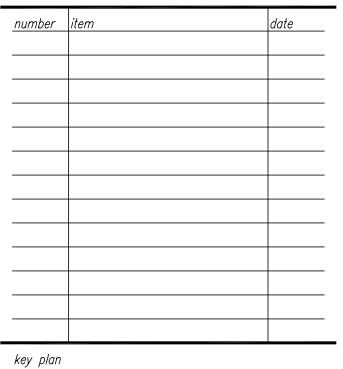
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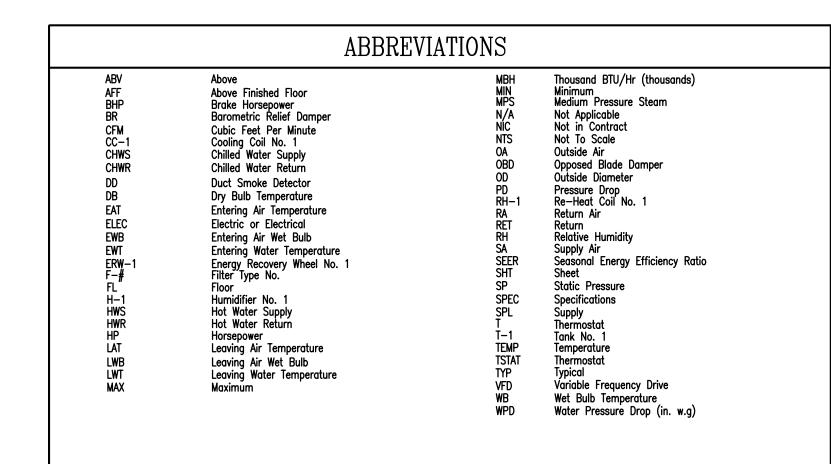
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sheet title

HVAC DETAILS

sheet number

M6.3



MECHANICAL GENERAL NOTES
1. DO NOT SCALE DRAWINGS; SEE ARCHITECTURAL DRAWINGS AND REFLECTED CEILING PLANS FOR EXACT LOCATIONS OF DOORS, WINDOWS, CEILING, DIFFUSERS, ETC.
2. EXTEND ALL DRAIN LINES TO EXTERIOR AND SPILL ON GRADE. ROUTE TO AVOID INTERFERENCE WITH PASSAGEWAYS. CONDENSATE DRAINS SHALL BE TRAPPED. SLOPE DRAIN LINES 1/8" PER FOOT.
3. ALL PIPING AND DUCTWORK INSULATION SHALL BE RUN CONTINUOUSLY THROUGH FLOORS, ROOFS AND PARTITIONS EXCEPT WHERE PROHIBITED BY FIRE CODES.
4. ALL PIPING SHALL BE SUPPORTED IN ACCORDANCE WITH THE SPECIFICATIONS AND FURTHER SUPPORTS OR HANGERS SHALL BE ADJACENT TO ELBOWS, TO PREVENT WEIGHT OF PIPING BEING PLACED ON THE EQUIPMENT. SUPPORT DETAILS SHALL BE SUBMITTED TO THE MECHANICAL ENGINEER.
5. ALL PIPING AND DUCTWORK LOCATIONS SHALL BE COORDINATED WITH THE WORK UNDER OTHER DIVISIONS OF THE SPECIFICATIONS TO AVOID INTERFERENCE.
6. ALL PIPING, DUCTS, VENTS, ETC. EXTENDING THRU EXTERIOR WALLS AND ROOFS SHALL BE FLASHED AND COUNTERFLASHED.
7. PROVIDE ALL TRANSITIONS REQUIRED FOR INSTALLATION OF DUCT, EXHAUST FANS, AND ALL OTHER EQUIPMENT AND APPURTENANCES.

8. ALL DUCT IS GALVANIZED SHEET METAL EXCEPT AS NOTED.

9. DUCT SIZES ARE CLEAR INSIDE DIMENSIONS.

- DRAWINGS SHOW GENERAL INTENT OF DEMOLITION. QUANTITIES, LOCATIONS, SIZES AND EQUIPMENT ARE SHOWN TO INDICATE TYPE OF SYSTEM INSTALLED AND DOES NOT NECESSARILY REPRESENT EXACT CONDITIONS. CONTRACTOR SHALL FIELD VERIFY BEFORE BIDDING.
 DEMOLITION OF EQUIPMENT, SYSTEMS, AND COMPONENTS SHALL INCLUDE ALL SUPPORTS, PADS, HANGERS, INSULATION, CONTROLS, STARTERS, ACCESSORIES, AND APPURTENANCES NOT REQUIRED FOR THE INSTALLATION OF THE NEW SYSTEM.
- SUPPORTS, PADS, HANGERS, INSULATION, CONTROLS, STARTERS, ACCESSORIES, AND APPURTENANCES NOT REQUIRED FOR THE INSTALLATION OF THE NEW SYSTEM.
 WHEN PARTIAL DEMOLITION OF A SYSTEM IS INDICATED, THE PART OF THE SYSTEM SHOWN TO REMOVED SHALL BE REMOVED TO THE ACTIVE MAIN OR BRANCH IF NOT REQUIRED FOR THE INSTALLATION OF THE NEW SYSTEM. THE ACTIVE MAIN OR BRANCH SHALL BE REPAIRED TO MATCH NEW INSTALLATION AS MUCH AS PRACTICAL. IF SYSTEM IS INSULATED, INSULATION SHALL BE PATCHED AND FINISHED REPAIR (IE: VAPOR BARRIER, COATING, ETC.)
 REMOVAL OF SYSTEMS SHALL INCLUDE COMPLETE SYSTEM WHENEVER PRACTICAL. IF NOT, SYSTEM (IE: PIPE, CONDUIT, ETC.) SHALL BE REMOVED TO 1 INCH BELOW SURFACE.

			HVAC LEGEND		
SYMBOL	DESCRIPTION	SYMBOL	DESCRIPTION	SYMBOL	DESCRIPTION
T	TEMPERATURE SENSOR OR THERMOSTAT	<u> </u>	CEILING SUPPLY DIFFUSER, RETURN GRILLE W/ FLEX DUCT CONN. FOR RETURN OR EXHAUST AIR; SEE "DIFFUSER & GRILLE SCHEDULE"	18x12 12x12	TRANSITION, FLAT ON BOTTOM (FOB) FLAT ON TOP (FOT, IF APPLICABLE)
\$	WALL SWITCH		EXISTING DUCT WORK TO REMAIN		TURNING VANES
\oplus	WALL HUMIDISTAT	*///////	EXISTING DUCT WORK TO BE REMOVED	- 000 -	DUCT SMOKE DETECTORS
•	CONNECT TO EXISTING		DUCT TURNING DOWN	CR	CONCEALED REGULATOR
18x12	RECTANGULAR DUCT SIZE, FIRST FIGURE IS SIDE SHOWN		DUCT TURNING UP		MANUAL VOLUME DAMPER
{ 18*ø	ROUND DUCT SIZE	—— ——	UNION	(A) 6"ø 100	A – DIFFUSER TAG 6"Ø – NECK SIZE 100 – CFM
- R -	CHANGE OF ELEVATION, RISER (R), DROP (0)		STRAINER		GATE VALVE
<u></u>	ACOUSTICAL LINING INSULATION		STRAINER WITH BLOW OFF		CONTROL VALVE, TWO WAY
	FLEXIBLE DUCT		ECCENTRIC REDUCER FLAT ON TOP		END CAP
CHWS	CHILLED WATER SUPPLY	-+0+-	TEE OUTLET UP	-+	ELBOW TURNED DOWN
CHWR	CHILLED WATER RETURN	-+0+	TEE OUTLET DOWN	-+0	ELBOW TURNED UP
	CONCENTRIC REDUCER				ECCENTRIC REDUCER FLAT ON BOTTOM

TAG	DESCRIPTION	NECK	MODULE SIZE	MOUNT	CONSTR.	MFGR	MODEL	NOTES
Α	SQUARE PLAQUE CEILING SUPPLY	AS SHOWN	24x24	LAY-IN	ALUMINUM	PRICE	SERIES ASPD	2,3
В	PERFORATED CEILING RETURN/EXHAUST	AS SHOWN	24x24	LAY-IN	ALUMINUM	PRICE	SERIES APDDR	3
С	SQUARE PLAQUE CEILING SUPPLY	AS SHOWN	16x16	SURFACE	ALUMINUM	PRICE	SERIES ASPD	2,3
D	PERFORATED CEILING RETURN/EXHAUST	AS SHOWN	16x16	SURFACE	ALUMINUM	PRICE	SERIES APDDR	3
E	LABORATORY SUPPLY DIFFUSER	AS SHOWN	AS SHOWN	LAY-IN	ALUMINUM	PRICE	SERIES	3
	RNISH WITH OPPOSED BLADE DAMPER							

						FAN SCHE	DULE			
TAG	TYPE	CAPACITY	E.S.P.	М	OTOR	ELECTRICAL	EMERGENCY	MANUFACTURER	MODEL NO.	NOTES
17.0	1112	CFM	(IN. WG.)	HP	RPM	(VOLTS/PHASE)	POWER	WATOTALIN	MODEL NO.	110123
LEF-1	VENT SET	6535	2.2	15	1725	460/3/60	NO	GREENHECK	VEKTOR-CD-15-1-III-MV	3,6,9,10,11,12,13
LEF-2	vent set	5465	2.2	15	1725	460/3/60	NO	GREENHECK	VEKTOR-CD-15-1-III-MV	3,6,9,10,11,12,13
EF-1	DOWNBLAST	100	0.375	1/6	1725	115/1/60	NO	GREENHECK	G-060-VG	2,3,4,5,8
1. MOTORIZED B 2. GRAVITY BACK 3. DISCONNECT 4. BIRDSCREEN		5. SEISMIC RO 6. BELT GUAR 7. FILTER 8. ECM MOTOR	D	10. F 11. C		PER SIST FLEX CONNECTION A 3R ENCLOSURE	13. SPRING ISOLATORS			

				STEAN	M HUMII	OIFIER S	CHEDUI	LE			
TAG	LOCATION	TYPE	DUCT SIZE	CFM	Capacity (LBS/HR)	STEAM PRESS. (PSIG)	MAXIMUM ABSORPTION DISTANCE	AIR PD (IN W.C.)	MANUFACTURER	MODEL	NOTES
H-1	RM 711	DUCT MOUNTED	38X18	11000	215	15	24"	0.051	DRI-STEEM	ultra-sorb LV	1,2,3,4,5,6
2. HI-LIMIT SEN 3. DUCT MOUNT	ATING CONTROL NSOR TED HUMIDITY SENSOR ON EMERGENCY POWER	5. PRESSURE AIR 6. STEAM TRAP	RFLOW PROVING SWITCH								

													ROOFTOP	UNIT S	CHEDULE	נ							
TAG	SERVICE	CAPACITY CFM	MINIMUM O.A.	FAN Type	STATIC IN. TOTAL		RPM	BHP	MOT RPM	OR HP	LAT UNIT (*F)	ELECTRICAL VOLTS/PHASE	EMERGENCY POWER	AIR VOLUME CONTROL	Preheat Coil Eq. No.	HEATING COIL EQ. NO.	COOLING COIL EQ. NO.	PRE-FILTER (%)	FINAL FILTER	HUMIDIFIER EQ. NO.	MANUFACTURER	MODEL	REMARKS
RTU-1	SUPPLY	11000	11000	AIRFOIL	7.58	3.5	2017	20.21	1800	25	55.0	480/3	YES	VFD	HC-1		CC-1	30	F-1A & F-1B		Trane	PERFORMANCE CLIMATE CHANGER-25	1,2
	IOUNTED VFD INT POWER CONNECT	ION																					

					F	ILTER SC	HEDULE					
TAG	SYSTEM	TYPE Media	CAPACITY (CFM)	Filter Depth (inches)	MAXIMUM AIR VELOCITY (FPM)	initial Press. Drop (in. Wg.)	Final Press. Drop (In. Wg.)	EFFICIENCY PERCENT	MERV Rating	MANUFACTURER	MODEL	NOTES
F-1A	RTU-1	PRE-FILTER	11000	4"	500	0.31	1.0	30	8	FARR	30/30	1
F-1B	RTU-1	FINAL FILTER	11000	12"	500	0.6	1.5	95	14	FARR	RIGA-FLO	1
. TEST METHO	DD: ASHRAE 52.1-	92 STANDARD										

						MA	KEUP	AIR V	ALVE S	CHEDU	LE						
TAG NO.	MAXIMUM	MINIMUM	MIN. INLET	PIPE RUNOUT			REH	IEAT COIL				PRIMARY NC @ 1.5" SP	inlet size	ELECTRICAL	MANUFACTURER	MODEL NO.	NOTE
170 110.	BOX CFM	BOX CFM	S.P. (W.C.)	SIZE (INCHES)	GPM	MBH	EWT (°F)	LWT (°F)	MAX. AIR VEL.	MAX COIL HT.	MAX. WPD	DISCH/RAD.	(INCHES)	(VOLTS/PHASE)	MANOTAGIONEN	MODEL NO.	NOIL
MAV-1	615	300	1.25	3/4"	1.2	11.7	160	140	900	12"	5		12	120/1	PHOENIX CONTROLS	MAVF12L	1,2,3
MAV-2	700	300	1.25	3/4"	1.2	11.7	160	140	900	12"	5		12	120/1	PHOENIX CONTROLS	MAVF12L	1,2,3
MAV-3	455	150	1.25	3/4"	0.6	5.9	160	140	900	10"	5		10	120/1	PHOENIX CONTROLS	MAVF10L	1,2,3
MAV-4	1375	195	1.25	3/4"	0.8	7.6	160	140	900	12"	5		24X12	120/1	PHOENIX CONTROLS	MAVA212L	1,2,3
MAV-5	4100	1495	1.25	1"	5.8	58.4	160	140	900	14"	5		28X14	120/1	PHOENIX CONTROLS	MAVA214M	1,2,3
MAV-6	835	150	1.25	3/4"	0.6	5.9	160	140	900	12"	5		12	120/1	PHOENIX CONTROLS	MAVF12L	1,2,3
MAV-7	730	150	1.25	3/4"	0.6	5.9	160	140	900	12"	5		12	120/1	PHOENIX CONTROLS	MAVF12L	1,2,3
MAV-8	1040	480	1.25	3/4"	1.9	18.7	160	140	900	12"	5		24X12	120/1	PHOENIX CONTROLS	MAVA212L	1,2,3

	-	_
1. HIGH SPEED	ELECTRIC ACTUATOR	
2. CONTROL PO	WER TRANSFORMER	
3. REHEAT COIL	MOUNTED IN DUCT	

TAG NO.	AREA SERVED	MAXIMUM	MINIMUM	MIN. INLET	PIPE RUNOUT		R	REHEAT COIL			PRIMARY NC @ 1.5" SP	inlet size	ELECTRICAL	MANUFACTURER	MODEL NO.	NOTE
IAG NO.	AREA SERVED	BOX CFM	BOX CFM	S.P. (W.C.)	SIZE (INCHES)	GPM	MBH	EWT (°F)	LWT (°F)	MAX. WPD	DISCH/RAD.	(INCHES)	(VOLTS/PHASE)	MANUFACTURER	MODEL NO.	NOIL
7VAV-1		470	140	1.0	3/4"	0.8	7.7	160	140	5		6	120/1	TRANE	VCWF-06	1,2
7VAV-2		400	120	1.0	3/4"	0.7	7.3	160	140	5		6	120/1	TRANE	VCWF-06	1,2
7VAV-3		260	80	1.0	3/4"	0.5	5.0	160	140	5		6	120/1	TRANE	VCWF-06	1,2
7VAV-4		260	80	1.0	3/4"	0.5	5.0	160	140	5		6	120/1	TRANE	VCWF-06	1,2
7VAV-5		260	80	1.0	3/4"	0.5	5.0	160	140	5		6	120/1	TRANE	VCWF-06	1,2
7VAV-6		1145	1145	1.0	1"	4.4	44.1	160	140	5		10	120/1	TRANE	VCWF-10	1,2
7VAV-7		700	210	1.0	3/4"	1.0	10.4	160	140	5		8	120/1	TRANE	VCWF-08	1,2
7VAV-8		900	450	1.0	3/4"	1.8	18.5	160	140	5		8	120/1	TRANE	VCWF-08	1,2
7VAV-9		115	115	1.0	3/4"	1.8	18.5	160	140	5		6	120/1	TRANE	VCWF-06	1,2

									ı	COIL	SCHE	DULE	ר נ										
			OADAOITY	MAX. AIR	MIN. FACE	AIR PRESS		CAPACITY			AIR TEMF	PERATURE		STE	AM		WATER		MAX	MINIMUM	MAXIMUM	EL EOTDIO AL	
TAG	LOCATION	SERVICE	CAPACITY CFM	VELOCITY (FPM)	AREA	DROP	TOTAL	SENS.	кw	ENTE	RING	LEAV	/ING	CAPACITY	PRESS.	ENTERING	LEAVING	GPM	PRESS DROP	NO. OF	NO. OF	ELECTRICAL (VOLTS/PHASE)	NOTES
			OTW	(FPM)	(SQ. FT.)	(IN. WG.)	MBH	MBH	L/M	DB °F	WB 'F	DB °F	WB 'F	(LBS/HR)	(PSIG)	TEMP. *F	TEMP. *F	OI W	(FT. WATER)	ROWS	FINS/FT.	(VOLIS/TTIASE)	<u> </u>
CC-1	RTU-1	COOLING	11000	500	23.73	1.251	1057.33	516.23		95.0	80.0	53.0	52.9			48.0	60.0	175.7	20	8	163		
HC-1	RTU-1	HEATING	11000	500	22.67	0.069	473.7			20.0		59.7		500.7	15				0.1	1	42		
																							<u> </u>
1. MINIMUM WA 2. 2-WAY VALV	er velocity — 3 f	FEET PER SECOND		3. 3-WAY VA 4. MINIMUM V		4 FEET PER SECO	ND																

TAG NO.	AREA SERVED	MAXIMUM BOX CFM	MINIMUM Box CFM	MIN. INLET S.P. (W.C.)	PRIMARY NC @ 1.5" SP DISCH/RAD.	INLET SIZE (INCHES)	ELECTRICAL (VOLTS/PHASE)	MANUFACTURER	MODEL NO.	NOTE
GEV-1		605	300	1.25		12	120/1	PHOENIX CONTROLS	EXVB12L	1,3,6
GEV-2		1065	600	1.25		12	120/1	PHOENIX CONTROLS	EXVB12L	1,3,6
GEV-3		1525	345	1.25		24X12	120/1	PHOENIX CONTROLS	EXVB212L	1,3,6
GEV-4		985	300	1.25		12	120/1	PHOENIX CONTROLS	EXVB12L	1,3,6
GEV-5		880	300	1.25		12	120/1	PHOENIX CONTROLS	EXVB12L	1,3,6
GEV-6		1190	110	1.25		12	120/1	PHOENIX CONTROLS	EXVB12L	1,3,6
GEV-7		4065	1460	1.25		28X14	120/1	PHOENIX CONTROLS	EXVB214M	1,3,6
GEV-8		915	600	1.25		12	120/1	PHOENIX CONTROLS	EXVB12L	1,3,6
,										

				H00	D EXHAUST	Γ VALVE	SCHEDULE			
TAG NO.	AREA SERVED	MAXIMUM BOX CFM	MINIMUM Box CFM	MIN. INLET S.P. (W.C.)	PRIMARY NC @ 1.5" SP DISCH/RAD.	INLET SIZE (INCHES)	ELECTRICAL (VOLTS/PHASE)	MANUFACTURER	MODEL NO.	NOTE
HEV-1		485	485	1.25		8	120/1	PHOENIX CONTROLS	EXVBF08L	1,3,4,6
HEV-2		485	485	1.25		8	120/1	PHOENIX CONTROLS	EXVBF08L	1,3,4,6
2. LOW SPEED	ELECTRIC ACTUATOR ELECTRIC ACTUATOR WER TRANSFORMER		5. CONNECT	N-RESISTANT COATING TO TWO POSITION WA CONTROL DIAGRAMS F						

]	PUMF	SCHEDULE				
TAG	SERVICE	TYPE	FLOW (GPM)	HEAD (FT)	EFFICIENCY (%)	HP	MOTOR HP RPM TYPE		ELECTRICAL (VOLTS/PHASE)	EMERGENCY POWER	MANUFACTURER	MODEL	NOTES
P-1B	SECONDARY CHILLED WATER	INLINE	200	56	59.5	7.5	1750	ODP	480/3	NO	BELL AND GOSSETT	SERIES 80 2-1/2 X 9-1/2B	1,2
INVERTER D VARIBABLE	UTY MOTOR FREQUENCY DRIVE												

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PHARMACY RENOVATION
State project number
H27- 6101
project number

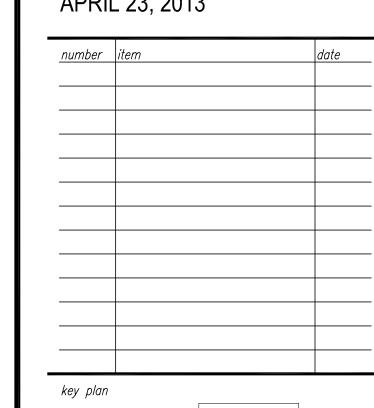
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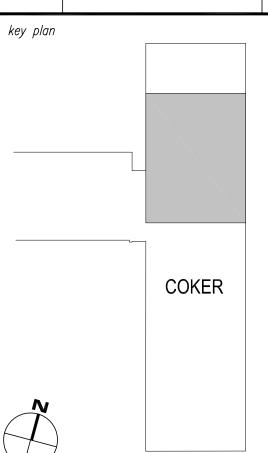
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